

П	VER	BY	AMENDMENTS	DATE
	Α	ВС	ORIGINAL ISSUE	22-05-2023
	В	ВС	LOTS UPDATED TO SUPERLOTS	31-05-2023
	С	ВС	ANNOTATION ON EASEMENTS	05-06-2023
Ш	D	ВС	REVISED BDY OF LOT 9/ROAD	06-09-2023
Ш	Е	ВС	REVISED BDY OF LOT 4	09-04-2024
l	F	ВС	REVISION TO EASEMENT NOTES	01-08-2024
V	G	ВС	REVISION TO LOT 16	18-10-2024
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**Development and Infrastructure Consultants** 


(02) 46255055 www.beveridgewilliams.com.au


LOT 1 IN DP326181, LOT 1 IN DP83742 AND LOT 1 IN DP595930 27-29 HOSPITAL ROAD, BULLI

ORIGINAL SCALE 1:1000
SHEET SIZE

SURVEYOR:	BC		
DRAWN:	AS		
CHECKED:	BC		
SURVEY DATE:	N/A		
CAD REFERENCE:	2300259-PS		
SHEET 1 C	DF 3		

1	PROJECT No. 2300259
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/	G	ВС	REVISION TO LOT 16	18-10-2024

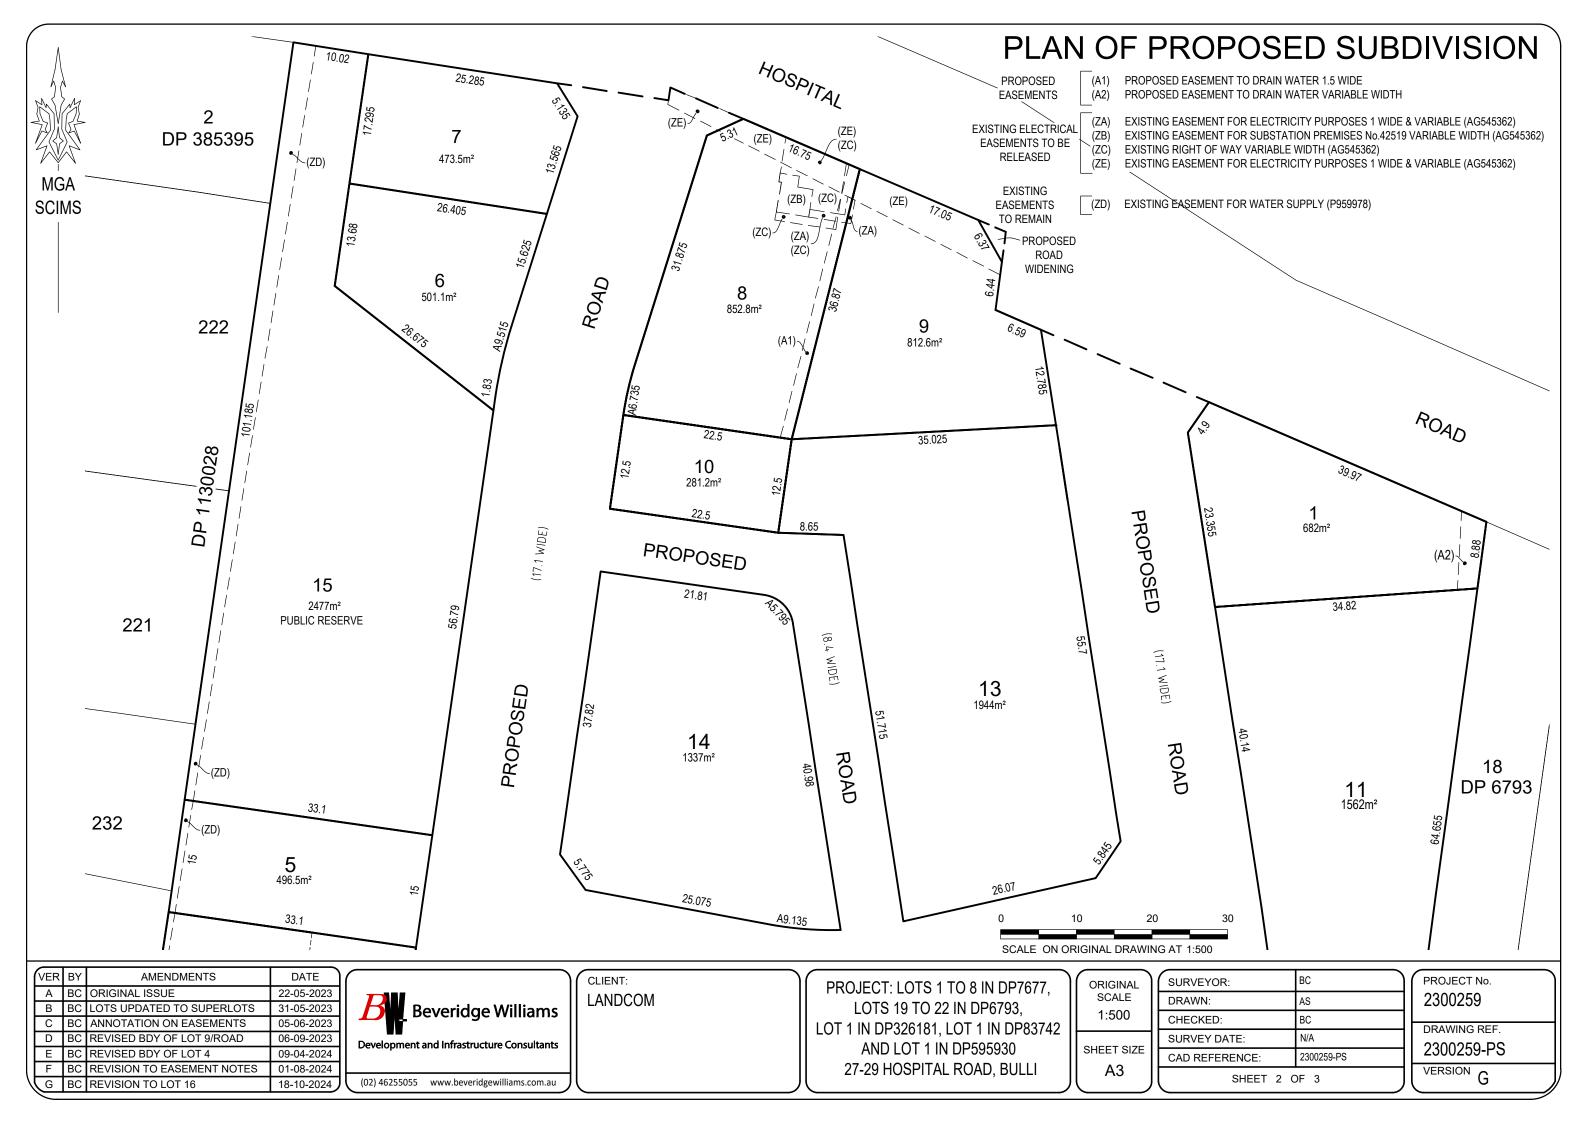Beveridge Williams

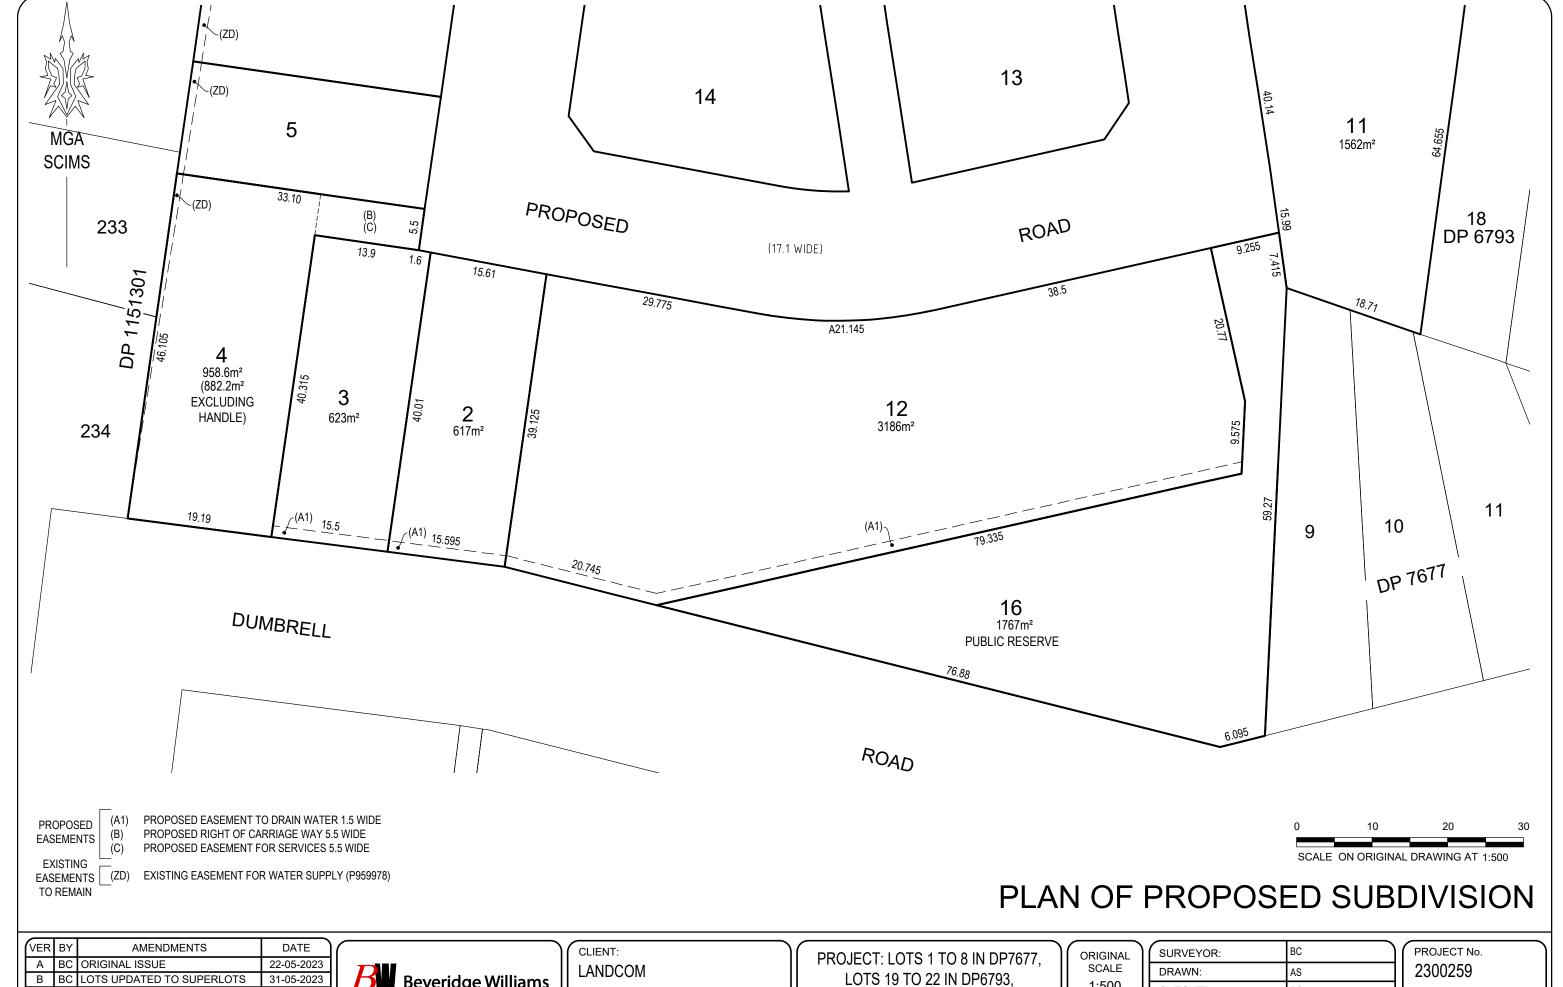**Development and Infrastructure Consultants** 

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LOTS 19 TO 22 IN DP6793, LOT 1 IN DP326181, LOT 1 IN DP83742 AND LOT 1 IN DP595930 27-29 HOSPITAL ROAD, BULLI

ORIGINAL SCALE 1:500
SHEET SIZE

SURVEYOR:	BC		
DRAWN:	AS		
CHECKED:	BC		
SURVEY DATE:	N/A		
CAD REFERENCE:	2300259-PS		
SHEET 3 C	DF 3		

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	VERSION G



### **ACKNOWLEDGEMENT TO COUNTRY**

'In the spirit of reconciliation Taylor Brammer Landscape Architects acknowledges the Traditional Custodians of country throughout Australia and their connections to land, sea and community.

We pay our respect to their elders past and present and extend that respect to all Aboriginal and Torres Strait Islander peoples today.'



#### **ISSUE AUTHORISATION**

Document Title: Old Bulli Hospital Landscape Master Plan

Project No: 22-112
Prepared for: Landcom
Prepared: SH/EE/HK
Reviewed: JH

#### **DOCUMENT/STATUS REGISTER**

Issue	Date	Purpose Written	Approved
01	12.05.2023	Preliminary Issue for Review	JH
02	18.05.2023	Preliminary Issue for Review	JH
03	24.07.2023	Final Review	JH
04	07.08.2023	Final Review	JH
05	24.08.2023	DA Submission	JH
06	12.09.2023	Final Review	JH
07	14.09.2023	Final Review	JH
08	27.09.2023	Final Review	JH
09	19.10.2023	Final Review	JH
10	31.10.2023	Final Review	JH
11	22.10.2024	DA Resubmission	JH
12	04.04.2025	DA Resubmission	JH
13	08.04.2025	DA Resubmission	JH

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# 1.1 Context






Regional



2.1 Built Form

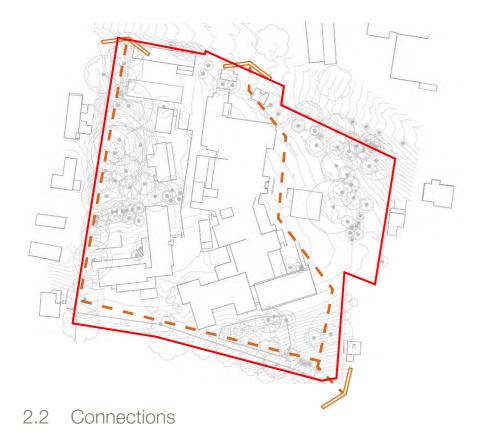


Site boundary

**⟨** - **⟩** 

Key existing pedestrian connection




2.3 Trees

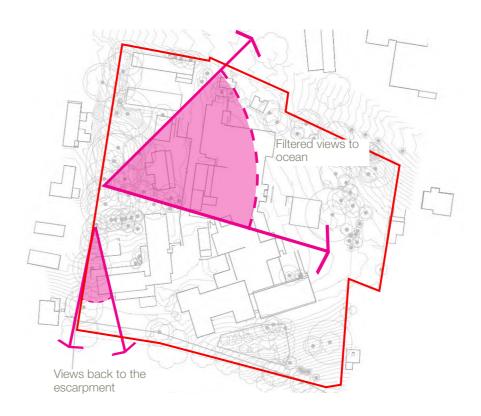


2.4 Views

#### LIST OF CHANGES

22.10.2024 - Analysis plan 2.3 updated to include additional trees retained in response to Wollongong City Council's RFI dated 2 August 2024

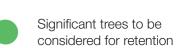

Site boundary

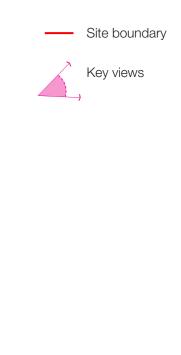

#### **DESIGN REVIEW PANEL ADVICE (DECEMBER 2022)**

On the 8th December 2022 a Design Review Panel was held to seek feedback on initial concept designs across the project team and consultants. The landscape presentation to the DRP included an introduction to the site, site analysis, an overview of the opportunities and constraints and the presentation of two initial concept designs based on the potential open space scenarios. The DRP provided the following feedback to be considered in design development:

#### **OPEN SPACE AND LANDSCAPING**

- Strongly supported the retention of significant trees
- Retaining the existing informal community access through the site
- Public spaces be fully accessible off public streets

#### **HERITAGE**

- Celebrate the site's history
- Recycling and repurposing site materials

This feedback was carried through to design development, with the existing significant trees celebrated and retained, accessibility thoughtfully considered within the limitations of maintaining existing ground levels around significant trees, and a thoroughfare pedestrian network connecting Hospital Road and Dumbrell Road (refer to 3.5 Design Principles). Feedback by the DRP on Heritage was considered alongside the Historical Heritage Assessment report by Austral Archaeology (2023) and this is evident in 3.4 Interpretation of Former Use.

#### **COMMUNITY CONSULTATION (4 FEBRUARY 2023)**

On Saturday 4 February 2023, Landcom held a second community information and feedback session in Bulli to share draft design concepts, provide an update on planned works, and invite community feedback to inform planning for the site. Landcom staff and technical consultants were available to answer questions and record feedback and comments.

Forty-six people attended the session. Attendees could provide comments on the three draft design concepts, features they would like to see in proposed open space, ways the site's history could be interpreted, and the planned works.

There were mixed views about the draft design concepts, with general preference for the concept with the lowest dwelling count (Concept A). There was also support for a mix of housing types to provide more affordable options and to provide more housing. There is widespread concern about future development exacerbating traffic issues on Hospital Road and parking constraints associated with the hospital. While a number of people recognise that well designed housing on the site is appropriate and will benefit the community, others oppose housing and want the site to be used for community facilities, open space or car parking.



Preferred layout from community consultation (concept A)

#### LIST OF CHANGES

22.10.2024 – Plan updated to include additional trees retained in response to Wollongong City Council's RFI dated 2 August 2024



# 3.0 Landscape Approach

3.2 Site Plan

The plan beside shows the proposed development layout with a connective road from the original entrances linking the entire site.

Based on feedback from the community consultation, the western precinct and southern precinct have been allocated as open space, with a pedestrian corridor throughout to connect the local community.

The western precinct includes numerous significant trees and filtered views, east to the coast and south-west to the escarpment. The southern precinct has a number of significant trees to the southern boundary providing a sense of site enclosure to the lower boundary of the site. The existing entrance is to include signage and retaining walls supported by mass planting.



LIST OF CHANGES

04.04.2025 – Plan updated to include additional trees retained and show additional trees removed in response to Wollongong City Council's comments on change of use of Hilltop Park

**NOTE**: All lot boundaries and driveways shown are indicative only. Lots are to be sold as super lots and lot boundaries and driveways are subject to change.



# 3.0 Landscape Approach

# 3.3 Tree Retention and Removal Plan



All existing trees have been coordinated with the Arborist report, as prepared by Allied Tree Consultancy (dated: August 2023).



04.04.2025 – Plan updated to include additional trees retained ato the Hill Top Park in response to Wollongong City Council's comments.

LIST OF CHANGES





# 3.0 Landscape Approach

# 3.4 Interpretation of Former Use

The following Heritage Interpretation is to be read in conjunction with the 'Historical Heritage Assessment' report by Austral Archaeology dated June 2023. Key findings from the report, alongside observations from site inspections, have informed the adjacent plan. The plan highlights opportunities within the landscape to effectively convey and commemorate the historical themes associated with the site.

The report notes that the site does not appear to have any identified heritage register at national, state or local level, however there is varying degrees of historical values. It was concluded that the only known value related to one phase of use "The Bulli Cottage Hospital". Built in 1892 and demolished in 1945. The exact location of this cottage on site is unknown.

The history detailed in the report for the Bulli Cottage Hospital is unique to the local context. The hospital was first established from a local committee that banded together following the 1887 Bulli Colliery Explosion (pg. 16-21). Another key finding from the report is the significance of the trees to the western edge of the site, which are recorded in the aerial photographs dating back to 1948.

Subsequent site inspections revealed the significant use of brick for many of the buildings. Brick evokes the story of community initiative and donation, as the building blocks for the hospital included bricks that were donated (pg.7). Unique forms of bricks can be seen in the variety of chimneys that dominate the skyline, along with the walls and pillars to the entrance gates to the old hospital.

To acknowledge the rich history of site into the future, where possible, some bricks from the site will be reclaimed for reuse within walls, garden beds and entry pillars. Interpretive signage throughout site will inform the community of the significance of the site, trees and celebrate key views.

#### LIST OF CHANGES

04.04.2025 – Plan updated to include a updated design to the Hill Top Park in response to Wollongong City Council's comments.

**NOTE**: All lot boundaries and driveways shown are indicative only. Lots are to be sold as super lots and lot boundaries and driveways are subject to change.



# 3.0 Landscape Approach3.5 Design Principles



# NOTE: All lot boundaries and driveways shown are indicative only. Lots are to be sold as super lots and lot boundaries and driveways are subject to change. Hospital Road

#### LIST OF CHANGES

04.04.2025 Plan updated to remove elements from Hilltop Park between retaining walls and replace with turf as requested by Council

# 4.0 Landscape Master Plan

# Softscapes Site Boundary Existing Contour Proposed Contour APZ Softscapes Mass Planting Turf Existing Tree Retained Proposed Tree Proposed Street Tree Hardscapes

DIALOGUE

Feature Pillar

Brick Faced Retaining Wall

Sandstone Retaining Wall


1200mm Balustrade Fence

Raised Boardwalk


Concrete Footpath

- 1 Planting along retaining wall softens the appearance of the retaining from the road, with cascading plants screening the wall and shrubs and small trees screening lot boundary fences.
- 2 Brick entry wall alludes to the site's historical use through its materiality and form. The use of additional planting helps to soften the entry and restablish the exisiting look and feel of the site.
- 2.5m high brick retaining wall with a 1200mm high balustrade. The wall to be clad in with bricks reclaimed from site and subject to Council consent as there is an opportunity to install interpretive signage on the wall relating to the sites past use.
- Existing trees to be retained in grass and maintained in accordance with the bush fire report recommendations
- 5 Driveway locations thoughtfully placed to ensure greatest street tree planting.
- Stairs from new road to Dumbrell Road maintains pedestrian connection through site.
- 7 Turfed open space with sandstone seating walls accomodating informal recreation and exercise surrounded by small areas of native planting.



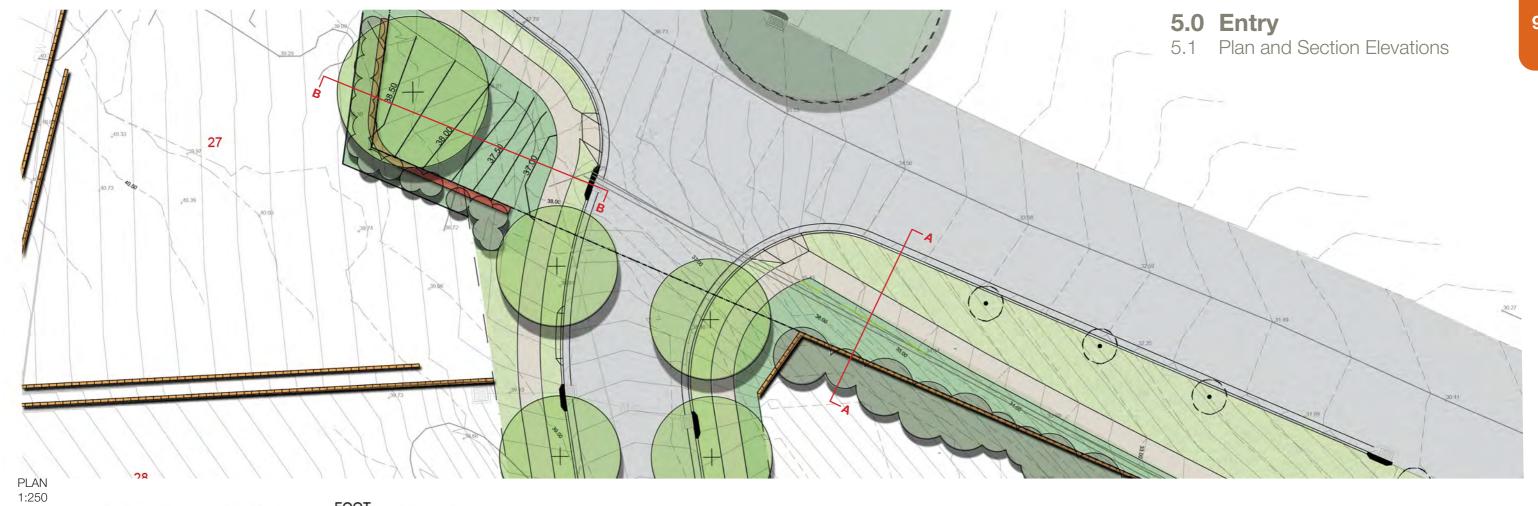



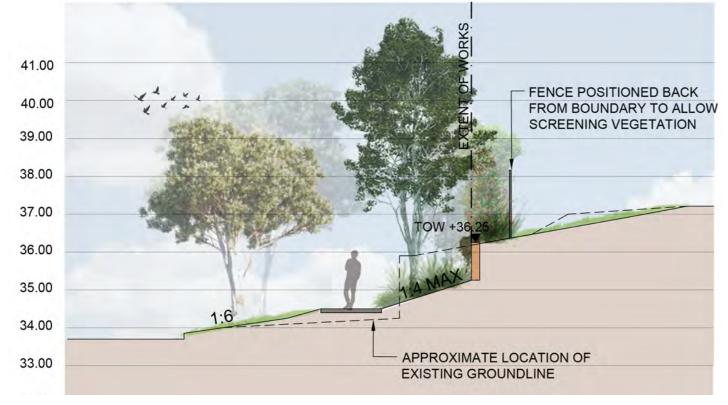

SECTION ELEVATION AA 1:100



#### LIST OF CHANGES

22.10.2024 - Plan and section elevations update to reflect the new design to the front entry of the site.

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6.0 Hilltop Park

6.1 Plan

#### DIALOGUE

- 1 Brick pillar signifies entry to park and alludes to historic use of site by materiality and form.
- 2 Turf to be maintained under existing trees in accordance with the bush fire report recommendations
- 3 A 2.5m high retaining wall clad in brick salvaged from the site to acknowledge the sites past use. There is an opportunity to provide additional interpretive signage on the wall. The wall to include a 1.2m high balustrade installed around the edge for public safety. This will be located in the garden bed to reduce maintenance
- 4 Terraced walls to match the existing grades of the park
- 5 A 1:5 turfed embankment allows for easy maintenance access into the Hilltop Park

#### **IMAGERY**



Potential to intengrate interpretive signage to the face of the retaining wall



Interpretive features from old hospital displayed throughout park



Heritage bricks reused in retaining walls

#### LIST OF CHANGES

04.042025 - Remove playground, access and viewing decks as directed by Wollongong City Council. Added 2.5m wall to retain existing trees.




1:400 @ A3 (1:200 @ A1)

EXISTING TREE PLANTING IN GRASS

6.0 Hilltop Park6.2 Sections and Elevations



KEY PLAN

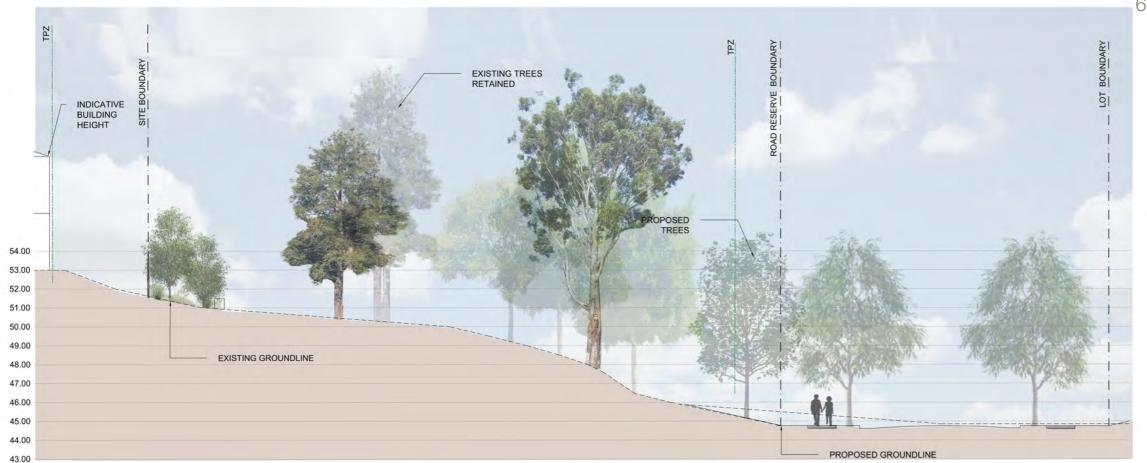




SECTION/ ELEVATION BB 1:200

LIST OF CHANGES

04.04.2025- Nature play, accessible ramps and viewing deck removed as instructed by Wollongong City Council



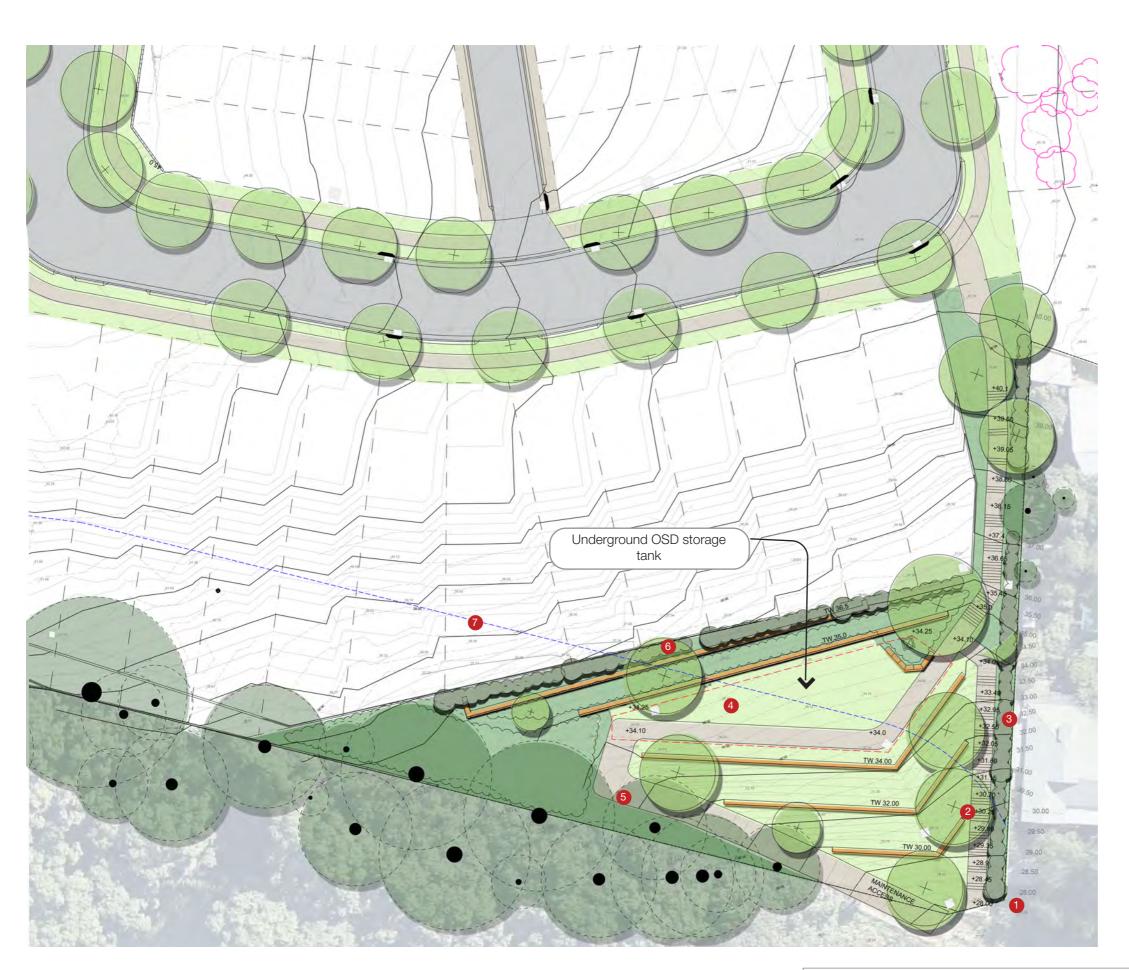

#### LIST OF CHANGES

04.04.2025 – Southern open space updated to remove planting between retaining walls. Grass slopes are shown with a max 1:4 grade as requested by Wollongong City Council

# 7.0 Southern Basin

#### 7.1 Plan

#### DIALOGUE

- 1 Brick pillar signifies entry to park and alludes to historic use of site by materiality and form.
- Elevated stairs continue material as used in Hilltop Park and connect Dumbrell Road to new road.
- 3 Dense screening along eastern site boundary creates a visual screen between Southern Basin and surrounding residents.
- 4 Turfed open space with sandstone log seating to also accomodate informal exercise
- Maintenance access utilises existing road to ensure minimal changes of ground level under existing trees.
- 6 Low groundcovers planted on terrace in accordance with bush fire report recommendations.
- Blue dashed line marks APZ extent from southern boundary. The planting within this extent align with APZ requirements as per Peterson Bushfire report dated 23 August 2023.

#### **IMAGERY**



Proposed sandstone retaining walls




Entry pillar included at base of stairs




Stair access to site



**KEY PLAN** 

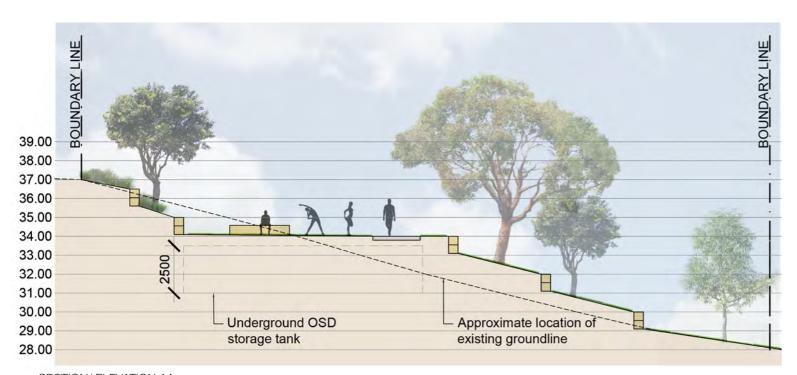


SECTION/ ELEVATION AA 1:200

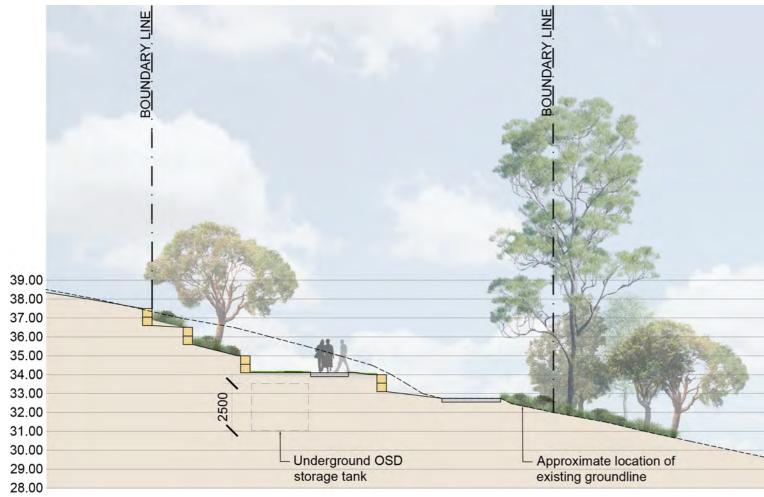

SECTION/ ELEVATION BB 1:200

## LIST OF CHANGES

04.04.2025 – Southern open space updated to remove planting between retaining walls. Grass slopes are shown with a max 1:4 grade as requested by Wollongong City Council

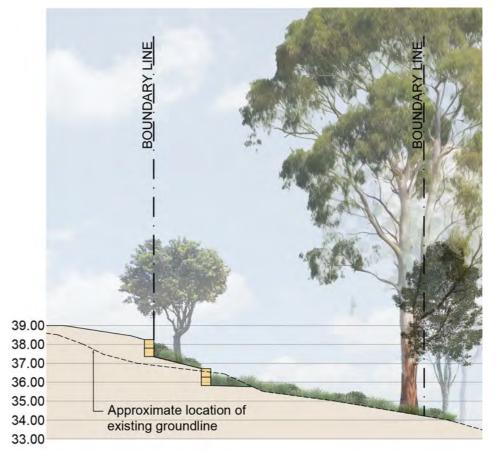

SECTION/ ELEVATION CC 1:200



#### **Pathway**

#### Design:

Concrete pathways to streetscapes to comply with councils DCP.

#### Materials:

Concrete pathway



#### Seating

#### Design:

- Provide large format seating
- Additional space for larger groups of people and pedestrians to pass comfortably

#### Materials:

Sandstone log





#### **Raised Walkway**

#### Design:

- Permeability to allow for water to pass through and drain naturally
- Minimal disturbance to the ground
- Level surface for pedestrians that does not impact existing tree

#### Materials:

- Fibreglass composite flooring
- Structural steel framing



#### Signage

#### Design:

- Directional signage will be placed strategically across the site at walkway intersections
- Interpretation signage will be placed at viewing and seating areas Material:
- Marine Grade Stainless steel panels fixed to the balustrade
- Large format steel panels





#### **Retaining Walls**

#### Design:

- Type: Brick clad Enginnered block wall (Hilltop Park)
- Type: Sandstone Wall (Southern Basins)
- Size: Varies

#### Materials:

- Bricks (reused from original building) used to clad wall
- Sandstone blocks, 1500mm x 500mm x 500mm





# Design: Reuse of Interpretive featuress in the landscape

 Reuse of material in landscape

**Interpretive Features** 

#### Material:

- Brick
- Terracotta







#### **Stairs**

#### Design:

- Stairs will be implemented at locations where there are level changes in the path of travel
- Permeability to allow for water to pass through and drain naturally
- Large stair landings to assist with pram and wheelchairs
- In accordance with AS1428.1

#### Materials


- Fibreglass composite treads at 300x150mm or 750 x 150 mm
- Structural steel framing
- Concrete







#### PLANTING STRATEGY

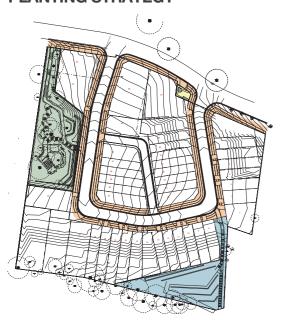

The street trees proposed have been selected to align with the existing character of the site. Melaleuca styphelioides is proposed along Hospital Road as an extension of the existing Melaleuca styphelioides planted in front of the retaining wall. Waterhousea floribunda is incorporated within the site due to it's suitable size and form for the streetscape.

The planting within Hilltop Park celebrates the history of the site. The combination of selected species and the retention of significant trees strengthens the current identity of the site. Additionally, the inclusion of indigenous plants reflects the cultural values and significance of the landscape.

Plant species selected for the Southern Open Space complements the existing wildlife corridor that runs along the southern boundary. The retention of existing trees are under planted with native grasses and groundcovers and create an ecologically rich corridor whilst aligning with planting requirements within the Asset Protection Zone (see Bushfire Assessment by Peterson Bushfire dated 24 August 2023).

#### STREETSCAPE INDICATIVE PLANT LIST

#### **TREES**

BOTANICAL NAME	COMMON NAME	HEIGHT	WIDTH	CULTURAL USES	ENTRY	STREETSCAPE	HILLTOP PARK	SOUTHERN OPEN SPACE
Acacia binervata	Two-veined Hickory	8m - 10m	2m - 3m	Υ				
Acacia longifolia	Sydney Golden Wattle	4m - 5m	2m - 3m					
Acacia maidenii	Maidens Wattle	6m - 8m	2m - 3m					
Allocasuarina torulosa	Forest Oak	8m - 10m	0.7 - 0.9m					
Banksia integrifolia	Coast Banksia	8m - 10m	5m - 6m					
Banksia serrata	Old Man Banksia	6m - 8m	3m - 4m					
Brachychiton acerifolius	Flame Tree	10m - 13m	2m - 4m					
Casuarina glauca	Swamp Oak	10m - 13m	2m - 4m					
Diospyros australis	Black Plum	8m - 10m	3m -5m	Υ				
Elaeocarpus reticlatus	Blueberry Ash	8m - 10m	3m - 4m	Υ				
Melaleuca linarifolia	Flax Leaf Paperbark, Snow in Summer	6m - 8m	6m - 7m	Υ				
Melaleuca styphelioides	Prickly Paper Bark	"10m - 13m	3m - 4m					
Podocarpus elatus	Illawarra Plum, Plum Pine	10m - 13m	6m - 7m	Y				
Syzygium australe	Brush Cherry	6m - 8m	3m - 4m	Υ				
Toona ciliata	Red Cedar	13m - 15m	2m - 4m					
Tristaniopsis laurina 'Luscious'	Water Gum	8m - 10m	4m - 5m					
Waterhousea floribunda	Weeping Lilly Pilly	13m - 15m	9m - 10m	Y				







Acacia maidenii

Acacia longifolia







Casuarina glauca Diospyros australis



Brachychiton acerifolius







Syzygium australe





Callistemon citrinus







Olearia tomentosa


Scaevola aemula 'Purple Fanfare'

#### SHRUBS SOUTHERN OPEN SPACE BOTANICAL NAME COMMON NAME CULTURAL USES STREETSCAPE HILLTOP PARK WIDTH FNTRY HFIGHT Acmena smithii Lilly Pilly 6m - 8m 3m - 4m Crinum pedunculatum Swamp Lily 1m - 1.5m 1.5m Small Leaved Bleeding Heart Homalanthus stillingiifolius 1m - 1.5m 0.4 - 0.9m Prostanthera incisa Cut-leaved Mint Bush 1.5m - 2m 1m - 1.5m 1m - 1.5m 1m - 1.5m Telopea speciosissima Waratah

LOW SHRUB (<1M) BOTANICAL NAME	COMMON NAME	HEIGHT	WIDTH	CULTURAL USES	ENTRY	STREETSCAPE	HILLTOP PARK	SOUTHERN OPEN SPACE
Callistemon citrinus	Crimson Bottlebrush	"1-2m - 3m"	1 - 1.5m	Υ				
Olearia tomentosa	Toothed Daisy Bush	0.6m	0.4 - 0.6m					
Scaevola aemula 'Purple Fanfare'	Fan Flower	0.3m	1m - 1.5m					

# 9.0 Planting Strategy

## **PLANTING STRATEGY**

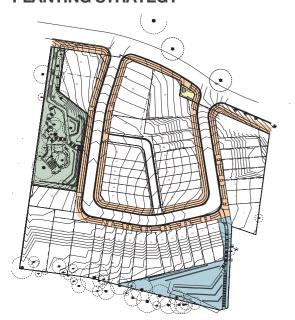

## **INDICATIVE PLANT LIST**

#### GRASSES

BOTANICAL NAME	COMMON NAME	HEIGHT	WIDTH	CULTURAL USES	ENTRY	STREETSCAPE	HILLTOP PARK	SOUTHERN OPEN SPACE
Austrodanthonia var. racemosa	Striped Wallaby Grass	0.6m	0.4 - 0.6m					
Austrostipa ramosissima		1m - 1.5m	0.7m -1m					
Carex appressa	Tall Sedge	1m	1m					
Dianella caerulea	Paroo Lily	0.8m	1m	Y				
Gahnia sieberiana	Red Fruited Saw Sedge	1m - 1.5m	1.5m	Y				
Lomandra longifolia	Mat Rush	1m	1m					
Lomandra Tanika	Mat Rush	0.5m	0.5m					
Microlaena stipoides	Weeping Grass							
Poa labillardieri	Tussock Grass	1m	1m					
Poa sieberiana	Grey Tussock Grass	1m	0.4 - 0.6m					
Themeda australis	Kangaroo Grass			Υ				

#### **FERNS**

BOTANICAL NAME	COMMON NAME	HEIGHT	WIDTH	CULTURAL USES	ENTRY	STREETSCAPE	HILLTOP PARK	SOUTHERN OPEN SPACE
Adiantum aethiopicum	Maidenhair Fern	0.4m	0.4 - 0.6m					
Asplenium australasicum	Bird's Nest Fern							
Blechnum cartilagineum	Gristle Fern	0.8m	0.4 - 0.6m	Y				
Pteris umbrosa	Jungle Brake	1m	1m					

#### **GROUNDCOVERS**

BOTANICAL NAME	COMMON NAME	HEIGHT	WIDTH	CULTURAL USES	ENTRY	STREETSCAPE	HILLTOP PARK	SOUTHERN OPEN SPACE
Dampiera purpurea	Dampiera	1m	0.4 - 0.9m	Y				
Goodenia ovata	Hop Goodenia	1.5m - 2m	2m - 3m					
Hardenbergia violaceae 'Happy Wanderer'	Purple Coral Pea	0.2m		Y				
Lobelia anceps	Lobelia	0.5m	0.4m - 0.6m					
Scaevola calendulacea	Dune Fan Flower	0.4m	0.4 - 0.6m					
Tetragonia tetragonoides	Warrigal Spinach	0.2m	0.7 - 1.5m	Υ				
Viola hederacea	Native Violet	0.2m	1m	Υ				











Poa labillardieri















Lobelia anceps






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PREPARED FOR:






LOT 1 DP326181, LOT 1 DP83742, LOT 1 DP595930, LOT 1 to 8 DP7677 & LOT 19 to 22 DP6793 LANDCOM - OLD BULLI HOSPITAL 27-29 HOSPITAL ROAD, BULLI PROPOSED SUBDIVISION - DA CIVIL DRAWINGS

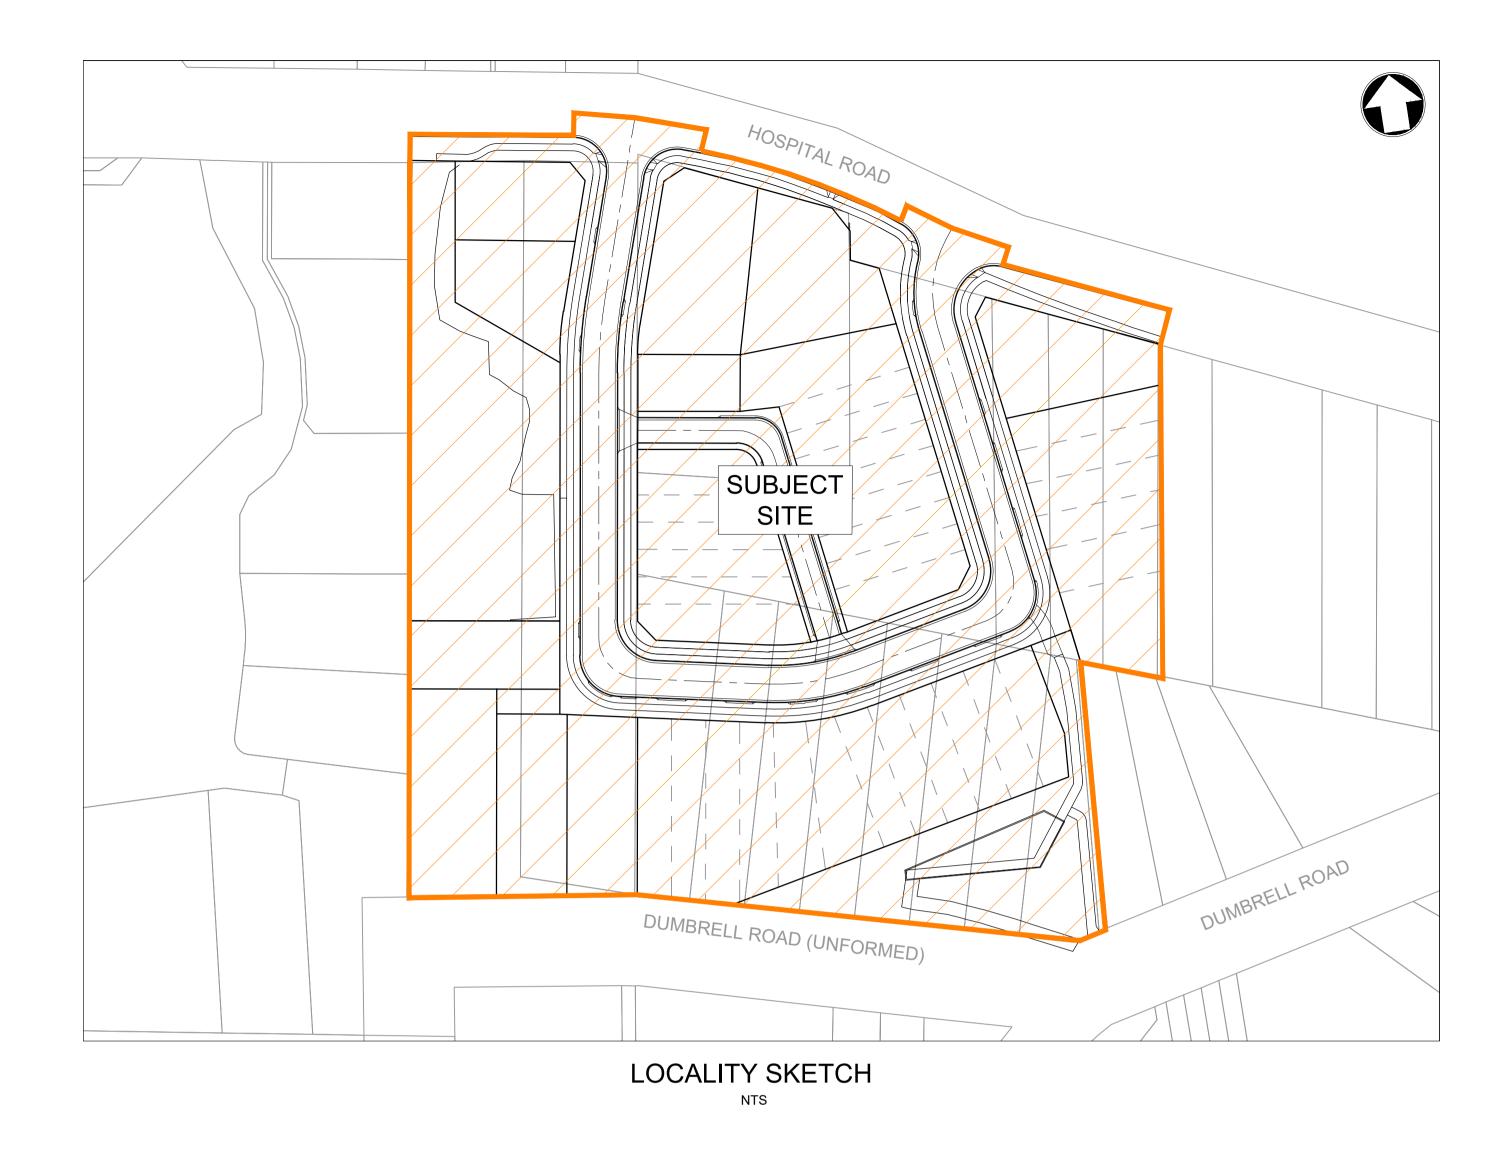ISSUED FOR DEVELOPMENT APPLICATION

NOT FOR CONSTRUCTION

22-526-DA-C010 H

03.10.2024

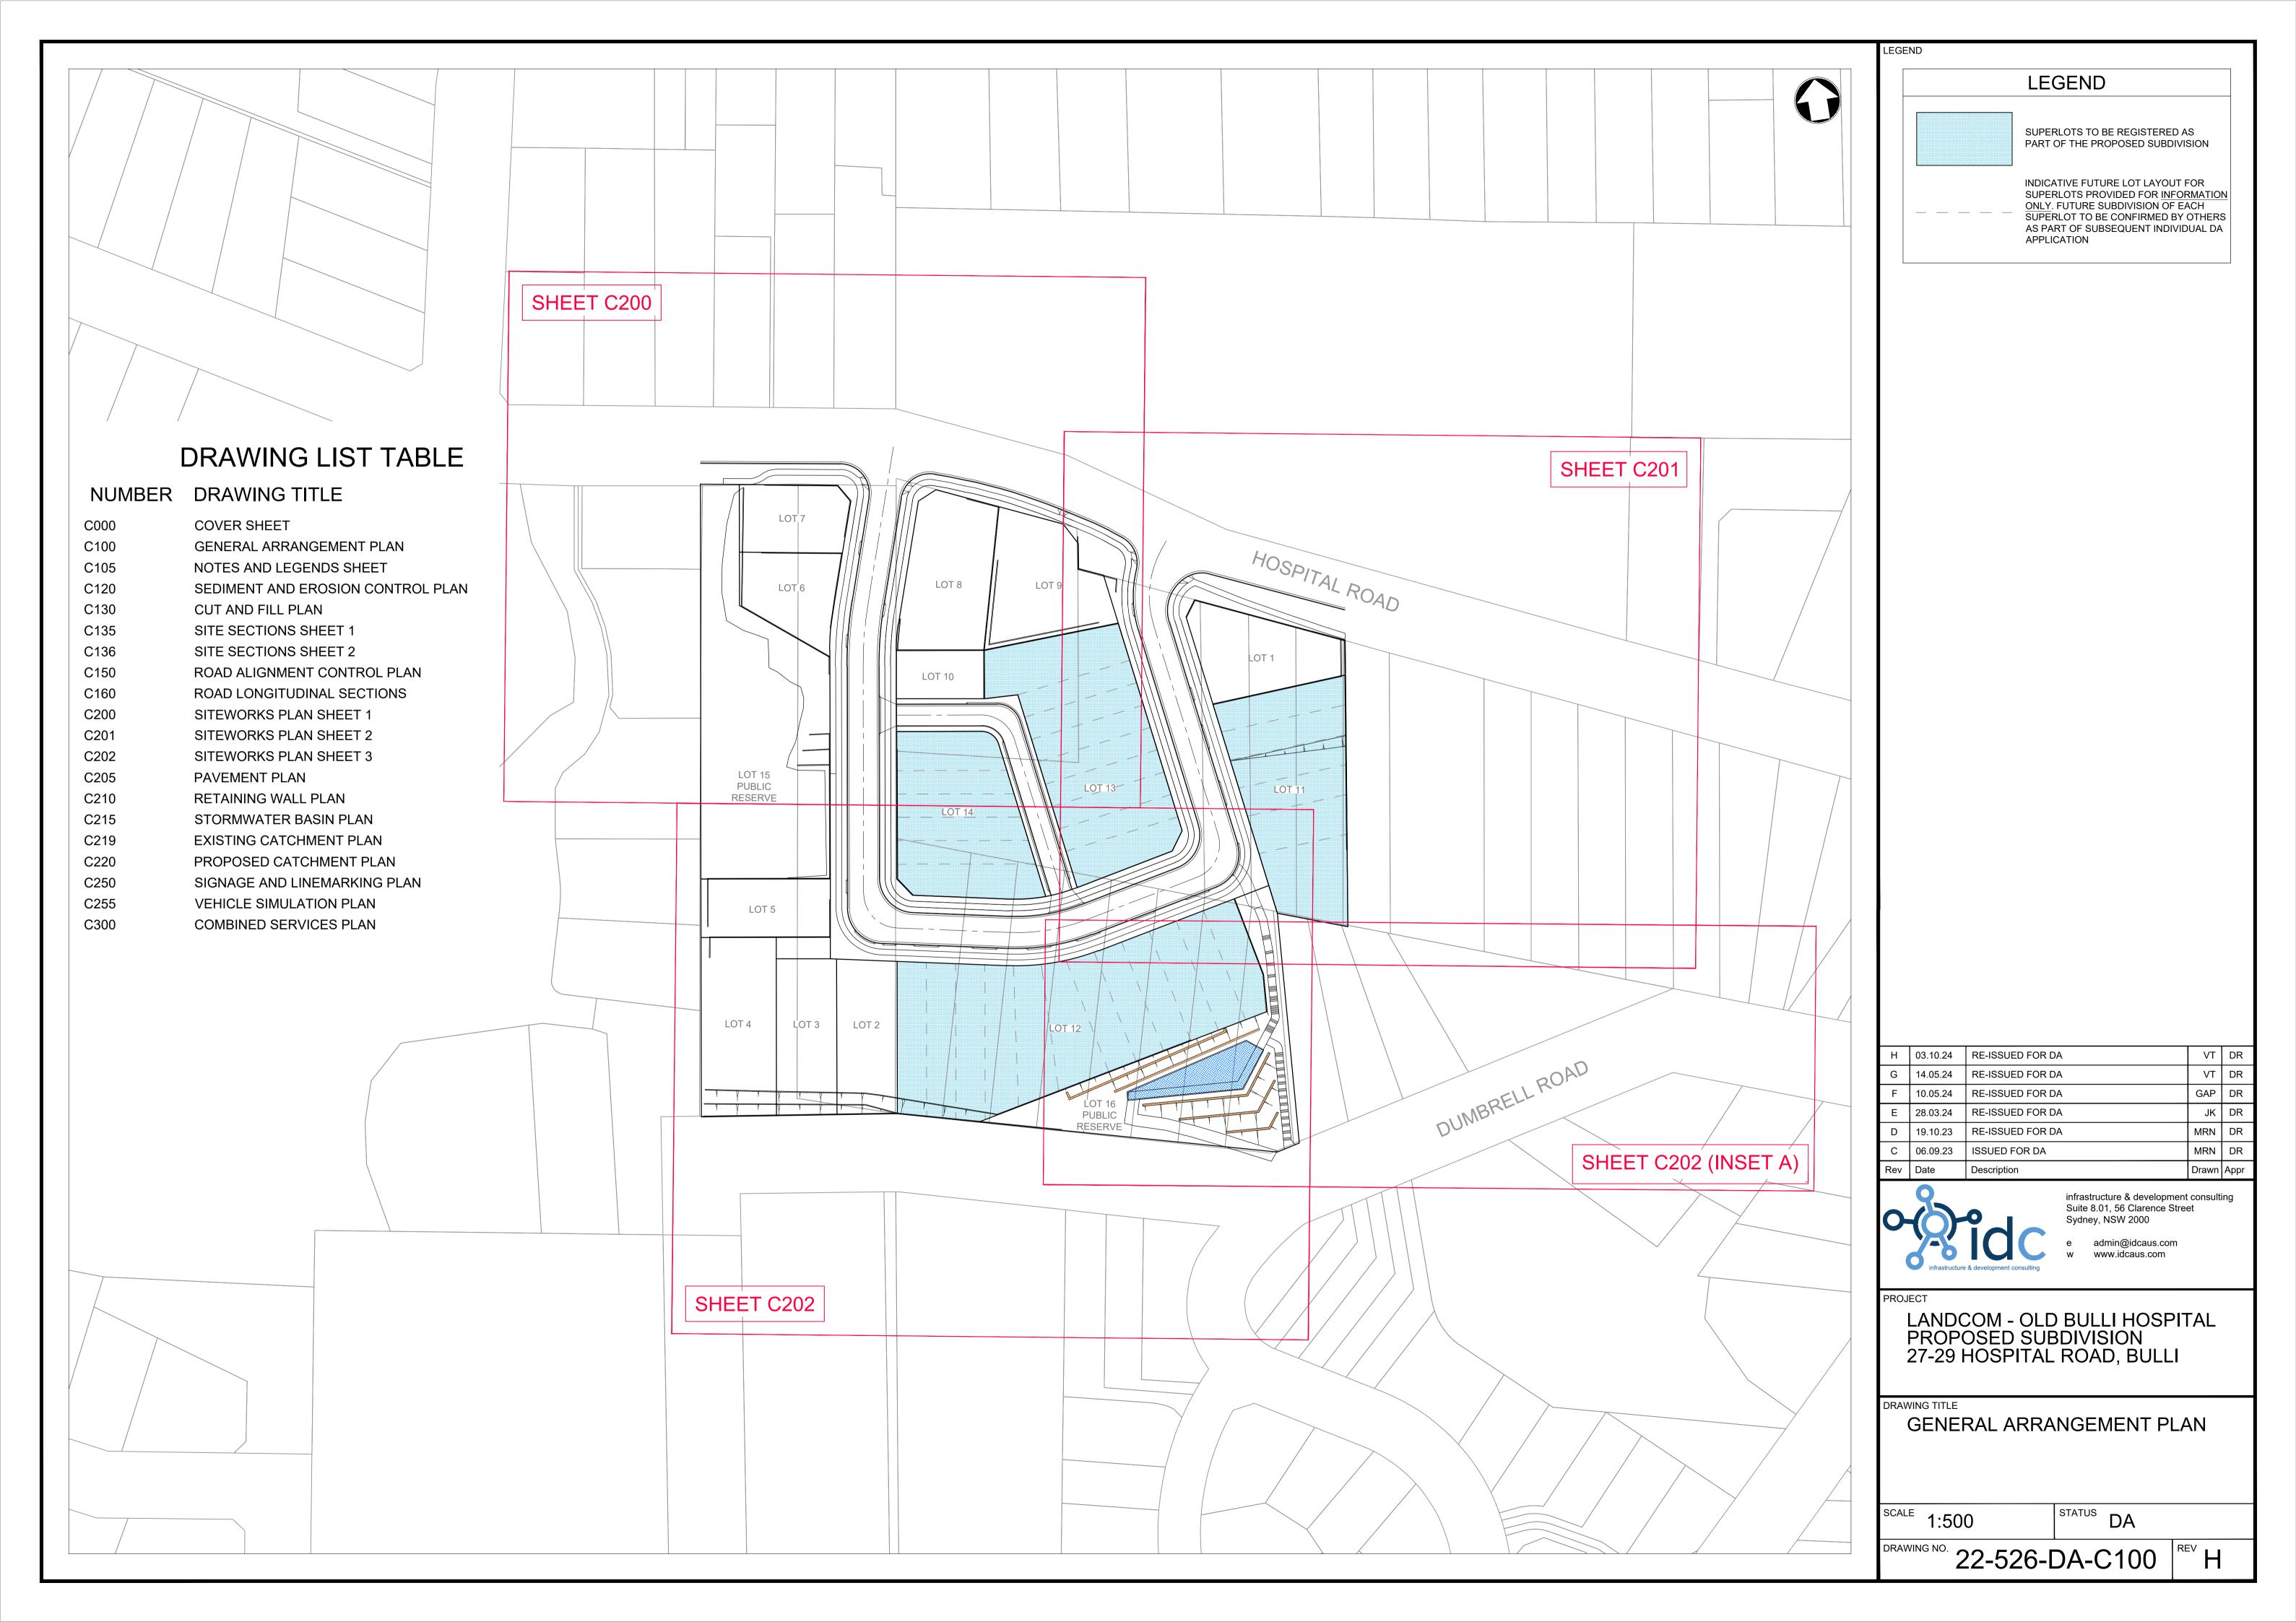

# GENERAL NOTES

- ALL WORKS TO BE CARRIED OUT IN ACCORDANCE WITH COUNCIL REQUIREMENTS AND / OR AS DIRECTED BY THEIR REPRESENTATIVE:
- 2. THESE DRAWINGS ARE TO BE READ IN CONJUNCTION WITH ALL RELEVANT COUNCIL SPECIFICATIONS AND OTHER CONSULTANT DRAWINGS. ANY DISCREPANCIES SHALL BE REPORTED TO THE SUPERINTENDENT FOR CLARIFICATION BEFORE PROCEEDING WITH THE WORK;
- THE CONTRACTOR SHALL NOT ENTER UPON NOR DO ANY WORK WITHIN ADJOINING PROPERTIES WITHOUT THE WRITTEN PERMISSION OF THE OWNERS OR THE RELEVANT **AUTHORITY**:
- NO TREES ARE TO BE REMOVED OTHER THAN THOSE NOTED ON PLAN WITHOUT FIRST OBTAINING WRITTEN PERMISSION FROM COUNCIL:
- TREES TO BE RETAINED ON SITE SHALL BE PROTECTED BY SUITABLE BARRIER FENCING OR APPROVED EQUIVALENT PRIOR TO THE COMMENCEMENT OF WORKS;
- 6. INFRASTRUCTURE & DEVELOPMENT CONSULTING ACCEPTS NO RESPONSIBILITY FOR ANY SURVEY INFORMATION PROVIDED. ALL SURVEY INFORMATION SHOULD BE CONFIRMED BY A REGISTERED SURVEYOR PRIOR TO CONSTRUCTION. ANY DISCREPANCIES, OMISSIONS OR ERRORS SHALL BE REPORTED TO THE SUPERINTENDENT FOR CLARIFICATION BEFORE PROCEEDING WITH THE WORK:
- SURVEY MARKS SHALL BE RETAINED AT ALL TIMES WHERE POSSIBLE. IF A SURVEY MARK IS TO BE REMOVED THE SUPERINTENDENT IS TO BE NOTIFIED AND THE CONTRACTOR IS TO FIRST OBTAIN CONSENT FROM THE DEPARTMENT OF LAND AND PROPERTY INFORMATION NSW PRIOR TO REMOVAL;
- 8. THE CONTRACTOR IS TO ARRANGE FOR ALL SITE SET OUT AND CONTROL POINTS BY A REGISTERED SURVEYOR;
- 9. IT IS THE CONTRACTORS RESPONSIBILITY TO LOCATE THE LINE AND LEVEL OF ALL EXISTING SERVICES PRIOR TO THE COMMENCEMENT OF ANY CONSTRUCTION WORKS AND MAKE ARRANGEMENTS TO RELOCATE OR ADJUST IF NECESSARY. ANY DISCREPANCIES SHALL BE REPORTED TO THE SUPERINTENDENT;
- 10. THE CONTRACTOR SHALL OBTAIN ALL REGULATORY AUTHORITY APPROVALS AT THEIR OWN EXPENSE;
- 11. THE CONTRACTOR SHALL MAINTAIN SERVICES AND ALL WEATHER ACCESS TO ADJOINING PROPERTIES AT ALL TIMES. IF REQUIRED THE CONTRACTOR SHALL PROVIDE TEMPORARY SERVICES TO MAINTAIN SUPPLY TO EXISTING BUILDINGS REMAINING IN OPERATION DURING THE WORKS. ONCE DIVERSION IS COMPLETE THE CONTRACTOR SHALL REMOVE ALL SUCH TEMPORARY SERVICES AND MAKE GOOD. ALL WORKS TO BE TO THE SATISFACTION OF THE SUPERINTENDENT AND THE RELEVANT SERVICE AUTHORITY;
- 12. CARE IS TO BE TAKEN WHEN EXCAVATING NEAR EXISTING SERVICES;
- 13. ALL NEW WORKS TO MAKE SMOOTH TRANSITION WITH EXISTING CONDITIONS;
- 14. THE CONTRACTOR SHALL UNDERTAKE ANY TEMPORARY TRAFFIC CONTROL MEASURES AS REQUIRED BY COUNCIL. ALL WORKS TO BE IN ACCORDANCE WITH COUNCIL'S TRAFFIC MANAGEMENT POLICY. ALL APPROPRIATE WARNING SIGNAGE TO BE DISPLAYED FOR THE DURATION OF THE WORKS:
- 15. ALL WORKMANSHIP AND MATERIALS TO COMPLY WITH THE RELEVANT CURRENT AUSTRALIAN STANDARDS AND LOCAL STATUTORY AUTHORITY CODES;
- 16. MEASUREMENTS ARE NOT TO BE SCALED FROM THE DRAWINGS;

# EARTHWORKS NOTES

- 1. ALL EARTHWORKS TO BE CARRIED OUT IN ACCORDANCE WITH AS3798 (2007) - GUIDELINES ON EARTHWORKS FOR COMMERCIAL AND RESIDENTIAL DEVELOPMENTS;
- 2. ALL WORK IS TO COMPLY WITH THE REQUIREMENTS OF THE PROJECT GEOTECHNICAL REPORT:
- 3. ALL UNSUITABLE, SOFT OR WET MATERIALS ARE TO BE REMOVED AND REPLACED PRIOR TO FILLING;
- 4. ALL FILL MATERIAL TO BE FROM A SOURCE APPROVED BY THE SUPERINTENDENT AND IS TO BE IN ACCORDANCE WITH THE REQUIREMENTS OF THE PROJECT GEOTECHNICAL REPORT PSM4313-007R DATED JUNE 2023 BY PELLS SULLIVAN MEYNINK;
- 5. ALL EARTHWORKS ARE TO BE CARRIED OUT IN ACCORDANCE WITH THE REQUIREMENTS OF THE EARTHWORKS SPECIFICATION OUTLINED IN THE PROJECT GEOTECHNICAL REPORT PSM4313-007R DATED JUNE 2023 BY PELLS SULLIVAN MEYNINK AND CHAPTER E19 OF THE WOLLONGONG DEVELOPMENT CONTROL PLAN:
- 6. ALL EARTHWORKS TO TAKE PLACE UNDER LEVEL 1 GEOTECHNICAL SUPERVISION UNLESS DIRECTED OTHERWISE BY THE SUPERINTENDENT OR THE CONDITIONS OF CONSENT. TESTING OF THE FILL MATERIAL SHALL BE CARRIED OUT BY AN APPROVED NATA REGISTERED LABORATORY;
- 7. EARTHWORKS TO BE STAGED SO THAT THE WORKING SURFACE IS ADEQUATELY DRAINED DURING THE PERIOD OF CONSTRUCTION;
- 8. IN AREAS OF FILL WHERE THE NATURAL SURFACE EXCEEDS 1(V):4(H) BENCHES ARE TO BE CUT TO PREVENT SLIPPING OF THE PLACED FILL MATERIAL AS REQUIRED BY THE SUPERINTENDENT:
- 9. ALL BATTERS TO BE SCARIFIED TO ASSIST WITH ADHESION OF TOPSOIL TO BATTER FACE;
- 10. THE CONTRACTOR IS TO CONTROL SEDIMENTATION, EROSION AND POLLUTION DURING EARTHWORKS IN ACCORDANCE WITH THE REQUIREMENTS OF "MANAGING URBAN STORMWATER: SOILS AND CONSTRUCTION";

# **CONCRETE NOTES**

- 1. ALL WORKMANSHIP AND MATERIALS SHALL COMPLY WITH AS 3600 (UNO);
- 2. CONCRETE MIX PARAMETERS
- MAXIMUM AGGREGATE SIZE = 20mm
- SLUMP = 80mm
- ALL CONCRETE MUST BE CONSOLIDATED WITH MECHANICAL VIBRATORS
- CONCRETE STRENGTH AS PER BELOW

# CONCRETE STRENGTHS (CIVIL WORKS ONLY)

USE	STRENGTH GRADE	CEMENT TYPE T
	(28 DAYS)	AS 3972
PITS	F'c = 32MPa	SL
PAVEMENTS	F'c = 32MPa	SL
KERBS	F'c = 25MPa	SL
MASS CONCRETE	F'c = 25MPa	GP

- 3. ALL REINFORCEMENT TO BE SUPPORTED IN ITS CORRECT POSITION DURING CONCRETING BY PLASTIC BAR CHAIRS. WIRE CHAIRS NOT PERMITTED. COVER MUST BE MAINTAINED AT ALL TIMES INCLUDING DRIP GROOVES. ENSURE TIE WIRES DO NOT PROTRUDE INTO THE COVER ZONE:
- 4. MINIMUM 40mm COVER TO REINFORCEMENT (UNO):
- 5. REINFORCEMENT AS SHOWN ON THESE PLANS IS REPRESENTED DIAGRAMMATICALLY AND NOT NECESSARILY SHOWN IN THE TRUE PROJECTION OR SCALE;
- 6. ALL CONCRETE TO BE CURED AS FOLLOWS:
- KEEP SURFACE CONTINUOUSLY WET FOR 3 DAYS: PREVENT MOISTURE LOSS FOR THE NEXT 4 DAYS USING POLYTHENE SHEETING OR WET HESSIAN PROTECTED FROM WIND AND TRAFFIC. AND THEN ALLOW DRYING OUT:

CURING COMPOUNDS MAY BE USED PROVIDED THAT THEY

- APPLY WITH AS3799 AND DO NOT AFFECT FINISHES; PVA BASED CURING COMPOUNDS MAY NOT BE USED.
- 7. REINFORCEMENT SYMBOLS AS FOLLOWS AS PER AS4671:
- HOT ROLLED DEFORMED BAR, GRADE 500 PLAIN ROUND BAR, GRADE 250
- HARD DRAWN WIRE FABRIC (SQUARE OR SL / RL
  - RECTANGULAR)
- 8. MINIMUM ALLOWABLE BEARING CAPACITY UNDER ALL CONCRETE FOUNDATIONS TO BE 150 KPa (UNO). BEARING CAPACITY TO BE CONFIRMED ON SITE BY A GEOTECHNICAL ENGINEER PRIOR TO COMMENCEMENT OF WORKS

# STORMWATER NOTES

- 1. STORMWATER DRAINAGE DESIGN CRITERIA:
- MINOR SYSTEM = 10YR ARI MAJOR SYSTEM = 100YR ARI
- 2. ALL STORMWATER PIPES Ø375 TO Ø600 SHALL BE CLASS 2 APPROVED SIGPOT AND SOCKET REINFORCED CONCRETE PIPES WITH RUBBER RING JOINT (UNO);
- 3. ALL STORMWATER PIPES Ø675 OR LARGER SHALL BE CLASS 3 APPROVED SIGPOT AND SOCKET REINFORCED CONCRETE PIPES WITH RUBBER RING JOINT (UNO);
- 4. ALL UPVC STORMWATER PIPES TO BE DWV CLASS GRADE SN8 IN ACCORDANCE WITH AS 1260 (UNO)
- 5. IT IS THE CONTRACTORS RESPONSIBILITY TO VERIFY THAT THE STORMWATER PIPE CLASSES SUIT THEIR CONSTRUCTION EQUIPMENT AND METHODOLOGY AND TO CHECK ALL CONSTRUCTION LOADINGS ON THE PIPES. THE CONTRACTOR MUST ENSURE THAT THE MINIMUM COVER ABOVE EACH PIPE IS MAINTAINED AT ALL TIMES:
- 6. ALL STORMWATER PIPES TO BE LAID AT A MINIMUM GRADE OF 1% (UNO);
- PIPE BEDDING TO BE TYPE H2 (UNO) FOR PIPES NOT UNDER PAVEMENTS AND TYPE HS2 FOR PIPES UNDER PAVEMENTS AS PER AS 3725. IN ALL CASES BACKFILL TRENCH WITH SAND TO 300mm ABOVE PIPE (UNO). WHERE PIPE IS UNDER PAVEMENT BACKFILL REMAINDER OF TRENCH TO UNDERSIDE OF PAVEMENT WITH SAND OR APPRVOED GRANULAR MATERIAL COMPACTED IN 150mm LAYERS TO MINIMUM 98% STANDARD MAXIMUM DRY DENSITY IN ACCORDANCE WITH AS 1289 5.2.1;
- 8. ALL CONNECTIONS TO EXISTING DRAINAGE PITS TO BE MADE IN A TRADESMAN LIKE MANNER AND THE INTERNAL WALL OF THE PIT AT THE POINT OF ENTRY TO BE CEMENT RENDERED TO ENSURE A SMOOTH FINISH WITH NO PROTRUSIONS:
- 9. ALL CAST-IN-SITU CONCRETE STOMRWATER PITS TO BE MINIMUM 32MPa AT 28 DAYS (UNO);
- 10. PRECAST CONCRETE PITS MAY BE USED IN LIEU OF CAST-IN-SITU PITS SUBJECT TO REVIEW AND APPROVAL BY THE SUPERINTENDENT;
- 11. STORMWATER PITS DEEPER THAN 1m TO HAVE STEP IRONS INSTALLED IN ACCORDANCE WITH THE LOCAL OR STATUTORY AUTHORITY REQUIREMENTS:
- 12. 3m LENGTH OF SUBSOIL DRAIN WRAPPED IN APPROVED FILTER SOCK TO BE PROVIDED AT THE INVERT OF EACH INCOMING UPSTREAM PIPE ON EACH PIT;
- 13. DRAINAGE LINES ON PLAN ARE DIAGRAMMATIC ONLY AND PIPE CENTRELINES ARE TO ENTER AND EXIT PITS AT THE CENTRE OF THE RESPECTIVE PIT WALLS (UNO);
- 14. THE BASE OF ALL STORMWATER PITS TO BE BENCHED TO FACILITATE THE SMOOTH FLOW OF WATER;
- 15. IT IS THE CONTRACTORS RESPONSIBILITY TO ENSURE ADEQUATE SAFETY MEASURES SHALL BE PUT IN PLACE AT ALL TIMES DURING CONSTRUCTION TO MITIGATE THE POSSIBILITY OF PERSONNEL FALLING DOWN PITS;


# ASPHALTIC CONCRETE NOTES


- ASPHALTIC CONCRETE MIX DESIGN, MANUFACTURE, PLACING AND COMPACTION TO BE IN ACCORDANCE WITH: THE REQUIREMENTS OF THE PROJECT GEOTECHNICAL REPORT: AND
  - COUNCIL'S RELEVANT CONSTRUCTION SPECIFICATION

# SIGNAGE AND LINEMARKING

- 1. ALL SIGNPOSTING AND LINEMARKING TO BE PLACED IN ACCORDANCE WITH THE FOLLOWING GUIDELINES: AS 1742.2 MANUAL OF UNIFORM TRAFFIC CONTROL DEVICES;
- COUNCIL'S RELEVANT STANDARDS.
- 2. LOCATIONS OF SIGNS SHOWN ON THESE PLANS ARE INDICATIVE ONLY. SIGNS TO BE SETOUT IN ACCORDANCE WITH THE REQUIREMENTS OF THE ABOVE GUIDELINES;
- 3. ALL STREET SIGNS TO BE CHARCOAL POWDER COATED (UNO)

# PAVEMENT LEGEND

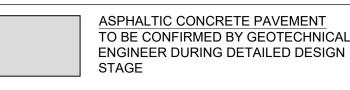

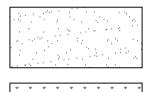


CONCRETE FOOTPATH PAVEMENT IN ACCORDANCE WITH COUNCIL DRAWING No. C22

PROPOSED LANDSCAPING

PLANS FOR DETAILS

LEGEND

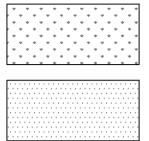

CONCRETE DRIVEWAY PAVEMENT IN ACCORDANCE WITH COUNCIL STANDARD DRAWING No. C30


REFER TO LANDSCAPE ARCHITECTS

ALL PAVEMENTS ARE INDICATIVE ONLY. TO BE CONFIRMED BY GEOTECHNICAL ENGINEER DURING SUBSEQUENT DETAILED **DESIGN STAGE** 

# **CIVIL WORKS LEGEND**

CONSTRUCT KERB AND GUTTER IN ACCORDANCE WITH COUNCIL DRAWING NO. C10

CONSTRUCT VEHICLE CROSSING IN

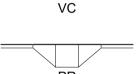

KG

DRAWING NO. C30 CONSTRUCT KERB PRAM RAMP IN ACCORDANCE WITH COUNCIL

ACCORDANCE WITH COUNCIL

CONSTRUCT BATTER

/ PIT NUMBER

DRAWING NO. C11

----- MINOR CONTOUR RW

PROPOSED LOT RETAINING WALL. REFER TO DRAWING C210 FOR DETAILS

PROPOSED LANDSCAPE WALL. REFER TO DRAWING C210 / LANDSCAPE ARCHITECTS PLANS FOR DETAILS STORMWATER DRAINAGE STRUCTURE

————10.0——— MAJOR CONTOUR



SURFACE INLET PIT/JUNTION PIT IN ACCORDANCE WITH COUNCIL DRAWING NO. C03


KERB INLET PIT WITH LINTEL IN

LINE WITH PIPE SIZE



ACCORDANCE WITH COUNCIL DRAWING NO. C01

PROPOSED STORMWATER DRAINAGE

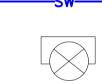

PROPOSED GROSS POLLUTANT TRAP "GPT". DETAILS TO BE CONFIRMED **DURING DETAILED DESIGN PHASE** 

TO SUIT INTER-ALLOTMENT DRAINAGE Ø150-Ø225 = 1m WIDE - >Ø300 = 1.5m WIDE

PROPOSED BELOW GROUND ON-SITE

STORMWATER DETENTION (OSD) TANK.

REFER TO DRAWING C215 FOR DETAILS

STORMWATER DRAINAGE EASEMENT

G 03.10.24 RE-ISSUED FOR DA VT DR RE-ISSUED FOR DA 14.05.24 10.05.24 RE-ISSUED FOR DA GAP DR 19.10.23 | RE-ISSUED FOR DA MRN DR MRN DR ISSUED FOR DA 06.09.23 14.07.23 ISSUED FOR INFORMATION GAP DR Rev Date Description Drawn Appr



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PROJECT

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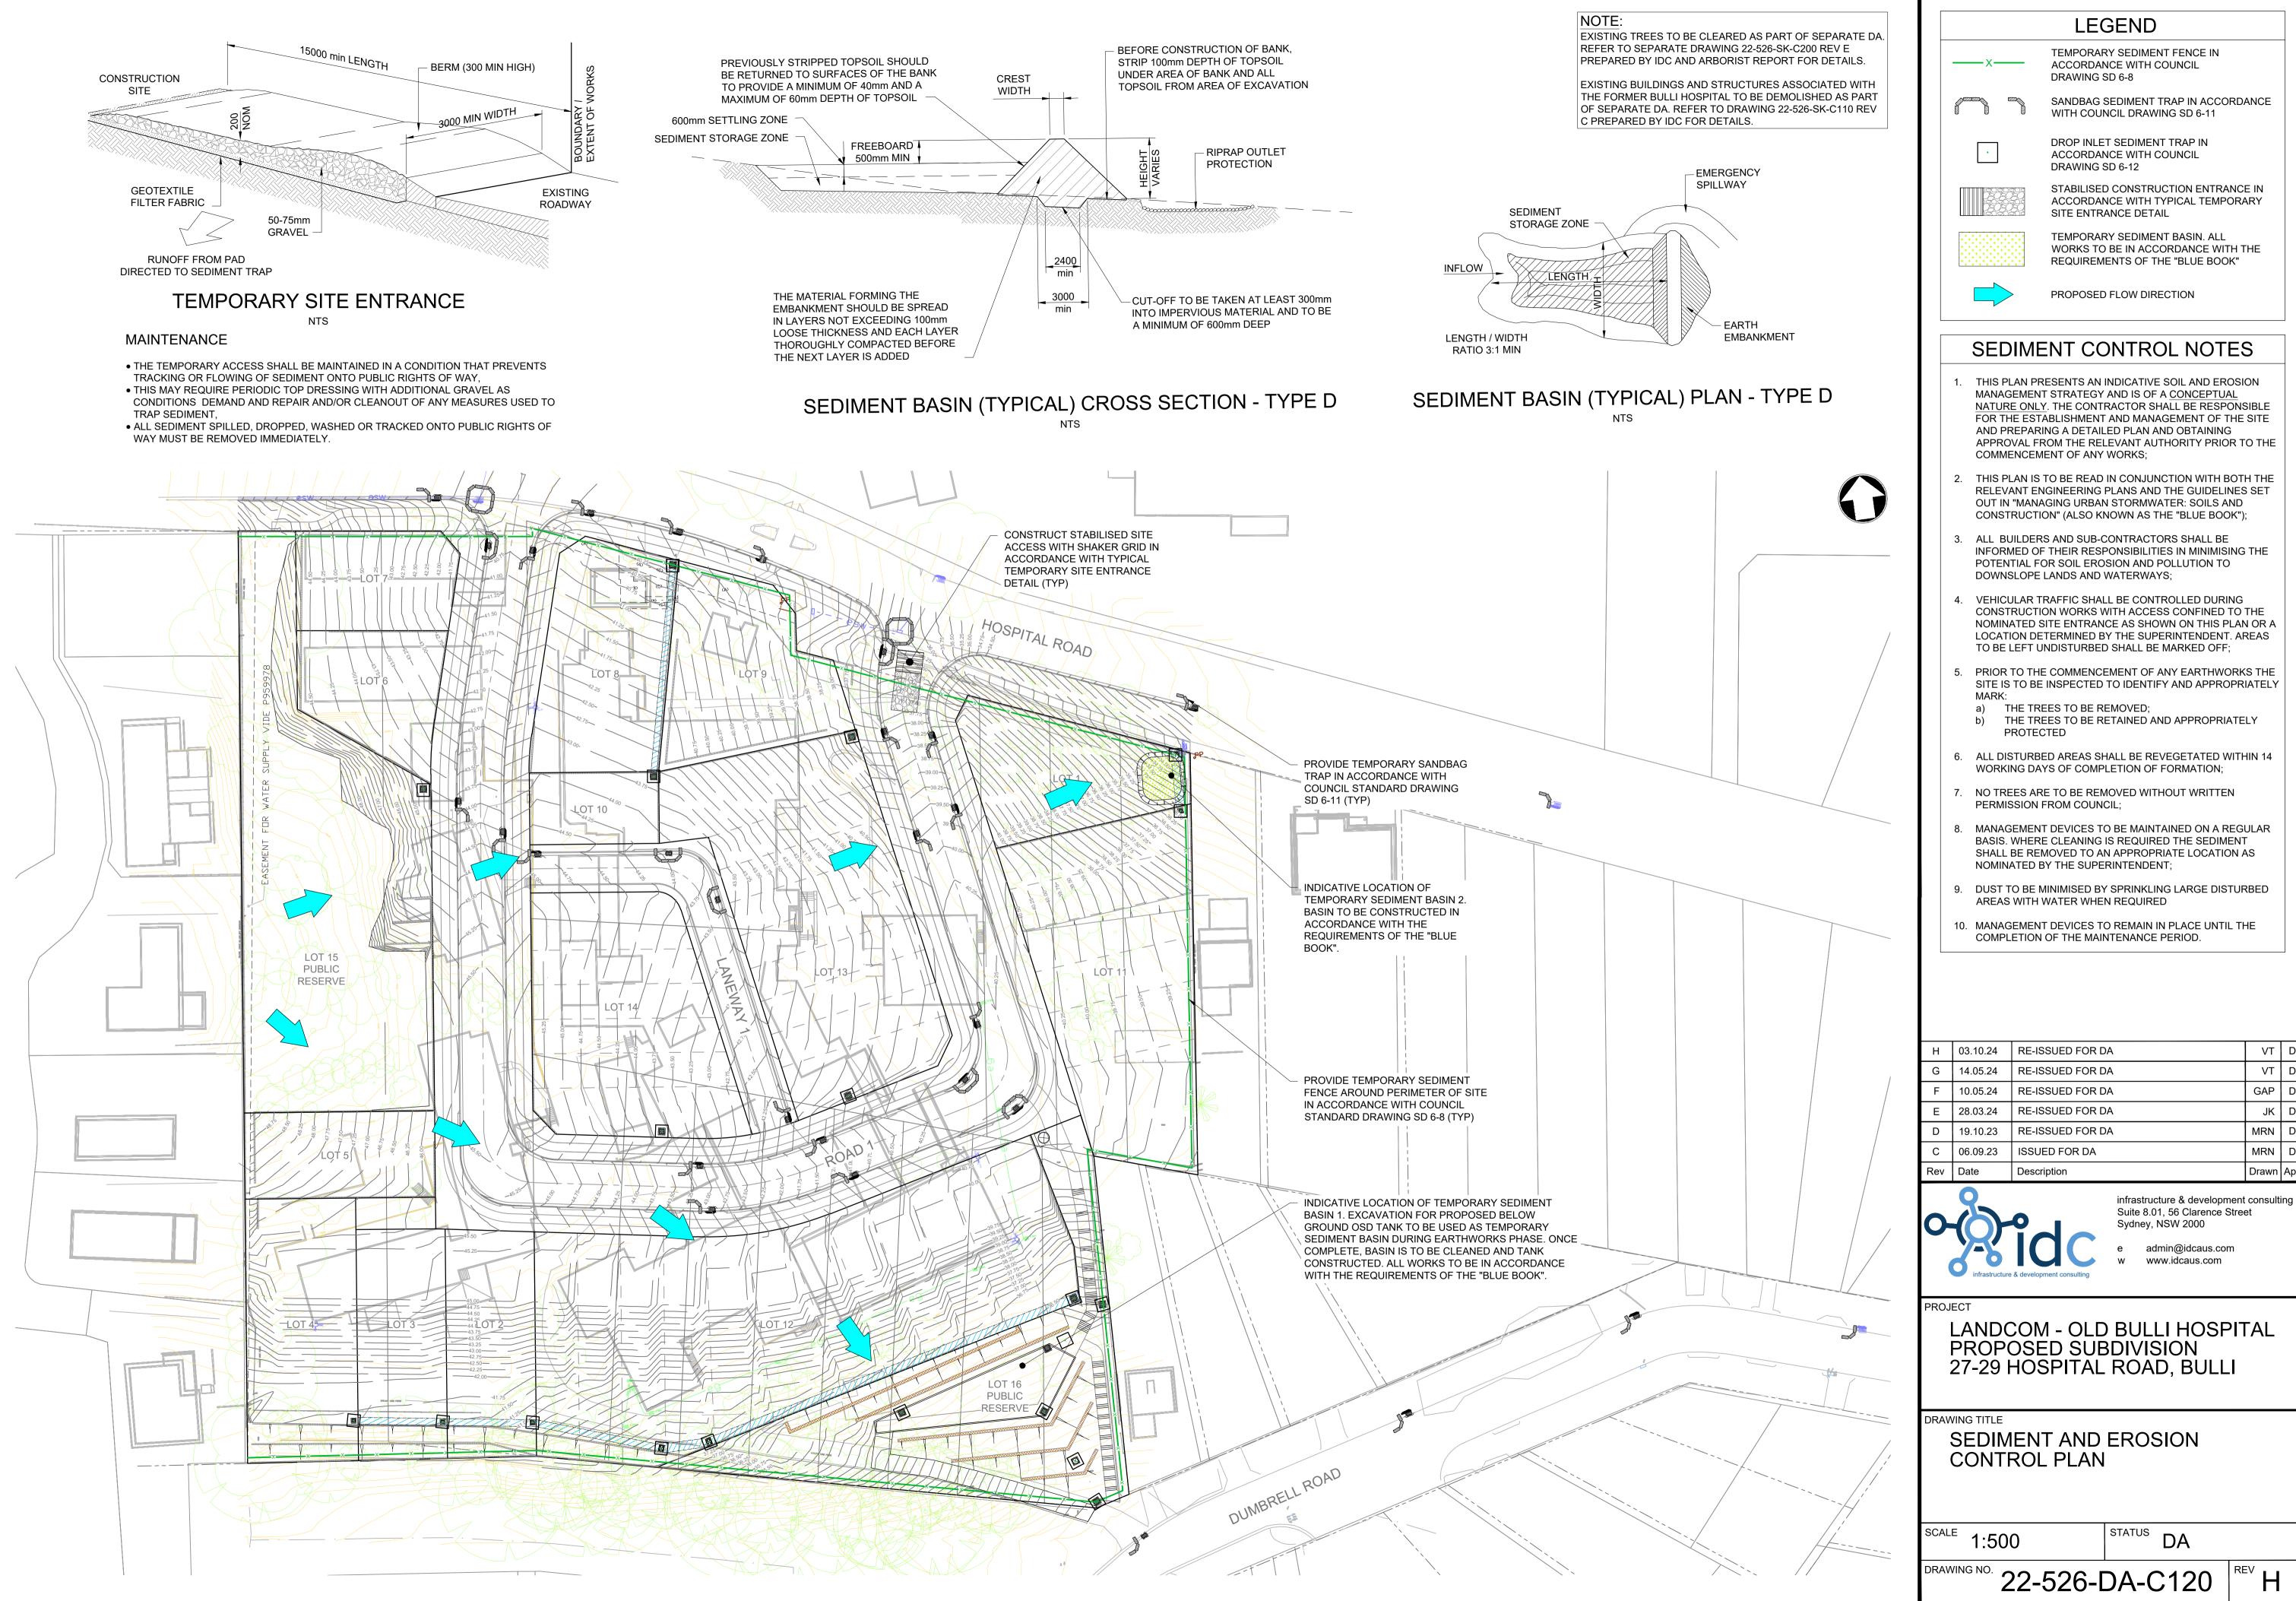
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NOTES AND LEGENDS SHEET

SCALE

STATUS DA

22-526-DA-C105 REV G





#### LEGEND

- NATURE ONLY. THE CONTRACTOR SHALL BE RESPONSIBLE FOR THE ESTABLISHMENT AND MANAGEMENT OF THE SITE APPROVAL FROM THE RELEVANT AUTHORITY PRIOR TO THE
- RELEVANT ENGINEERING PLANS AND THE GUIDELINES SET OUT IN "MANAGING URBAN STORMWATER: SOILS AND
- INFORMED OF THEIR RESPONSIBILITIES IN MINIMISING THE
- CONSTRUCTION WORKS WITH ACCESS CONFINED TO THE NOMINATED SITE ENTRANCE AS SHOWN ON THIS PLAN OR A LOCATION DETERMINED BY THE SUPERINTENDENT. AREAS
- SITE IS TO BE INSPECTED TO IDENTIFY AND APPROPRIATELY
- BASIS. WHERE CLEANING IS REQUIRED THE SEDIMENT SHALL BE REMOVED TO AN APPROPRIATE LOCATION AS

1	03.10.24	RE-ISSUED FOR DA	VI	DR	
ì	14.05.24	RE-ISSUED FOR DA	VT	DR	
:	10.05.24	RE-ISSUED FOR DA	GAP	DR	
Ξ	28.03.24	RE-ISSUED FOR DA	JK	DR	
)	19.10.23	RE-ISSUED FOR DA	MRN	DR	
;	06.09.23	ISSUED FOR DA	MRN	DR	
٧	Date	Description	Drawn	Appr	

LANDCOM - OLD BULLI HOSPITAL PROPOSED SUBDIVISION

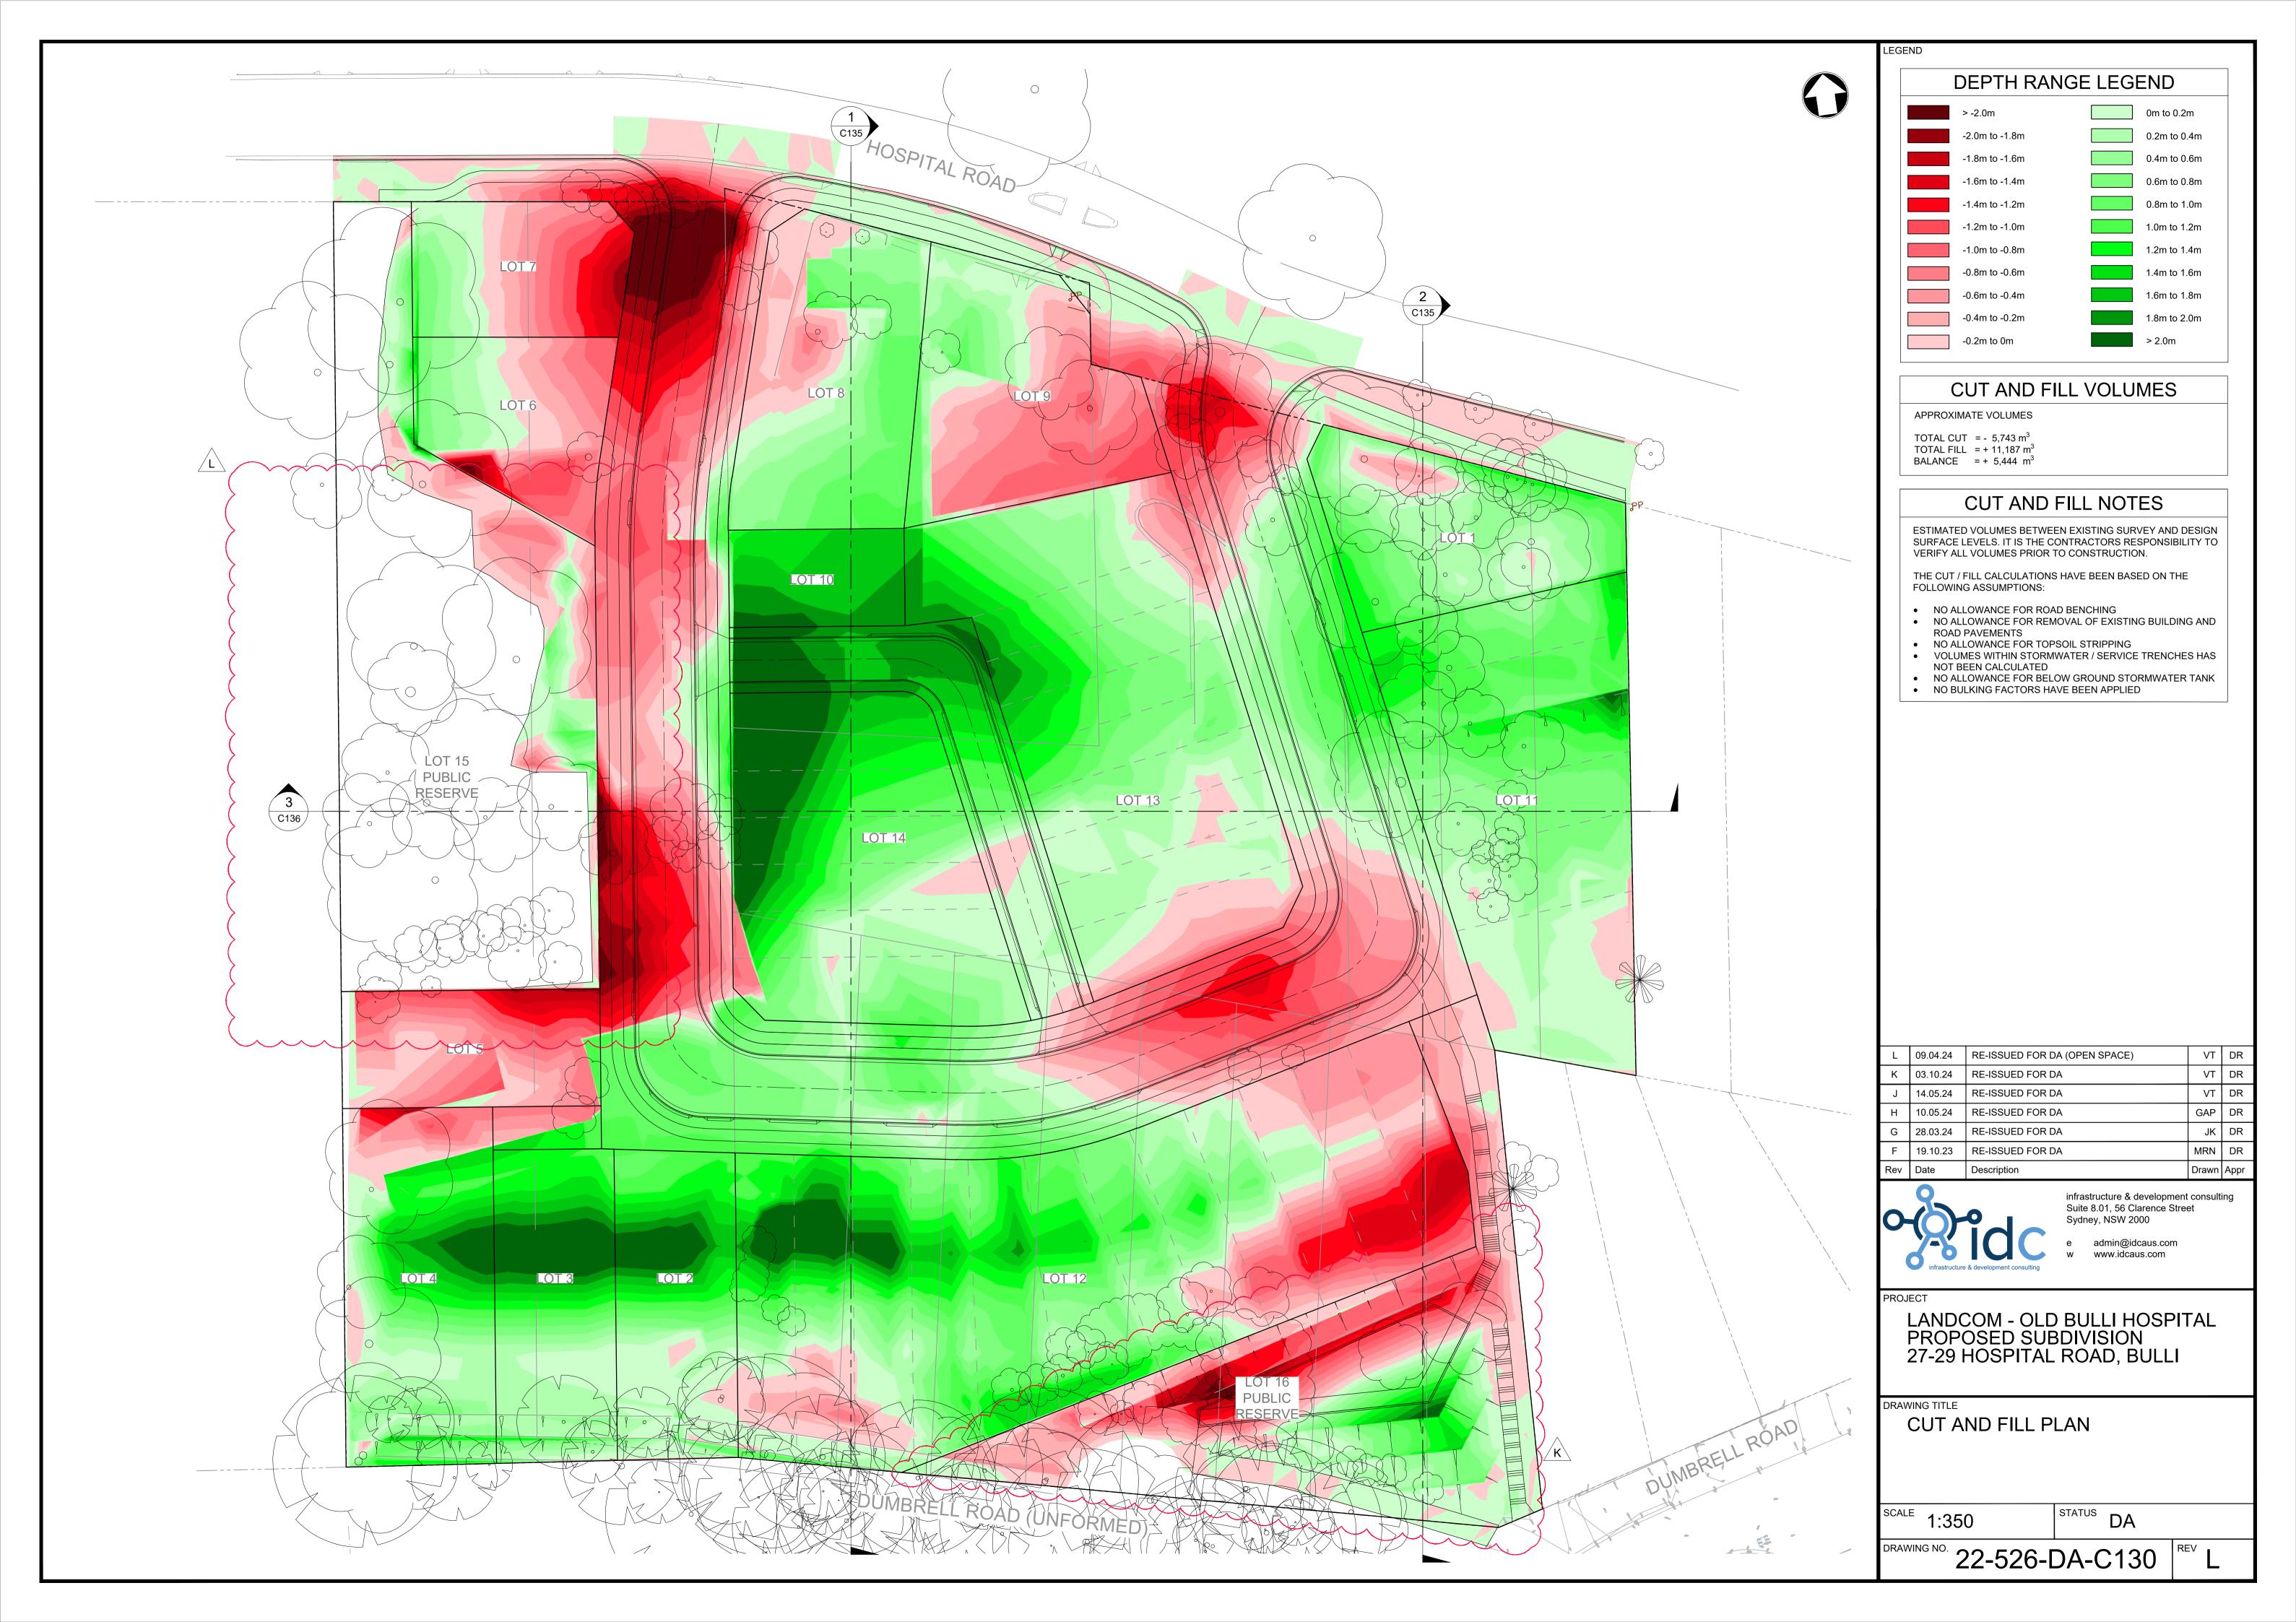

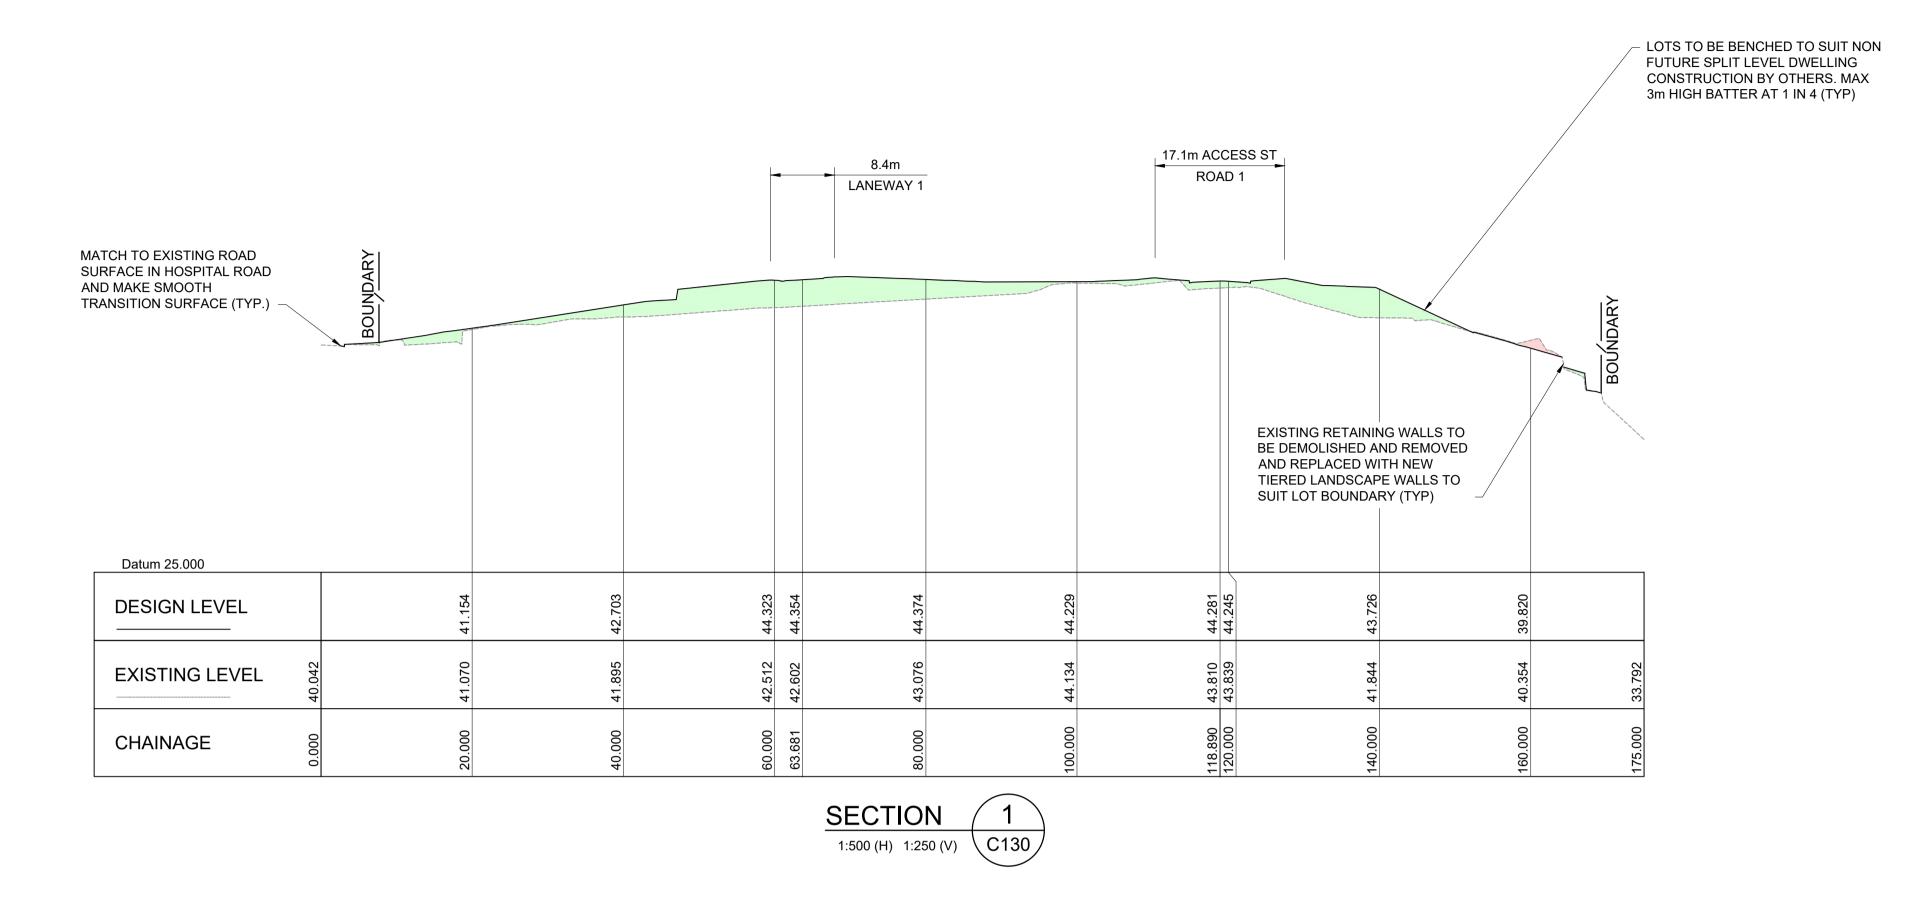

SECTION

1:500 (H) 1:250 (V) C130

34.000

31.809

137.942 140.000

36.685

EXISTING CONCRETE CRIB WALL TO BE DEMOLISHED AND REMOVED AND

REPLACED WITH NEW WALL ALONG LOT BOUNDARY

DOWNSTREAM VERGE LEVELS IN HOSPITAL ROAD AND MAKE SMOOTH TRANSITION (TYP)

MATCH TO EXISTING ROAD

AND MAKE SMOOTH

Datum 20.000

CHAINAGE

DESIGN LEVEL

**EXISTING LEVEL** 

SURFACE IN HOSPITAL ROAD

TRANSITION SURFACE (TYP.) -

MATCH TO EXISTING

F 03.10.24 RE-ISSUED FOR DA RE-ISSUED FOR DA GAP DR D 10.05.24 RE-ISSUED FOR DA MRN DR C 19.10.23 RE-ISSUED FOR DA MRN DR B 06.09.23 ISSUED FOR DA A 16.06.23 ISSUED FOR INFORMATION JG DR infrastructure & development consulting Suite 8.01, 56 Clarence Street Sydney, NSW 2000



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LEGEND

LEGEND

PROPOSED CUT AREAS

PROPOSED FILL AREAS


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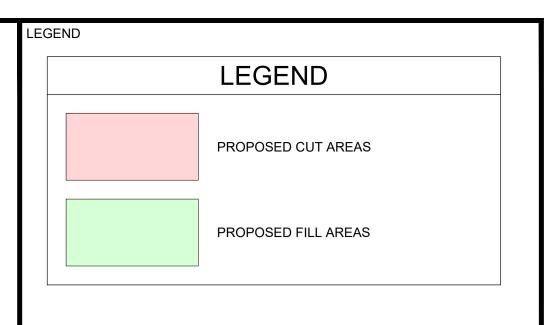
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SITE SECTIONS SHEET 1

SCALE 1:500, 1:250

DRAWING NO. 22-526-DA-C135 | REV F



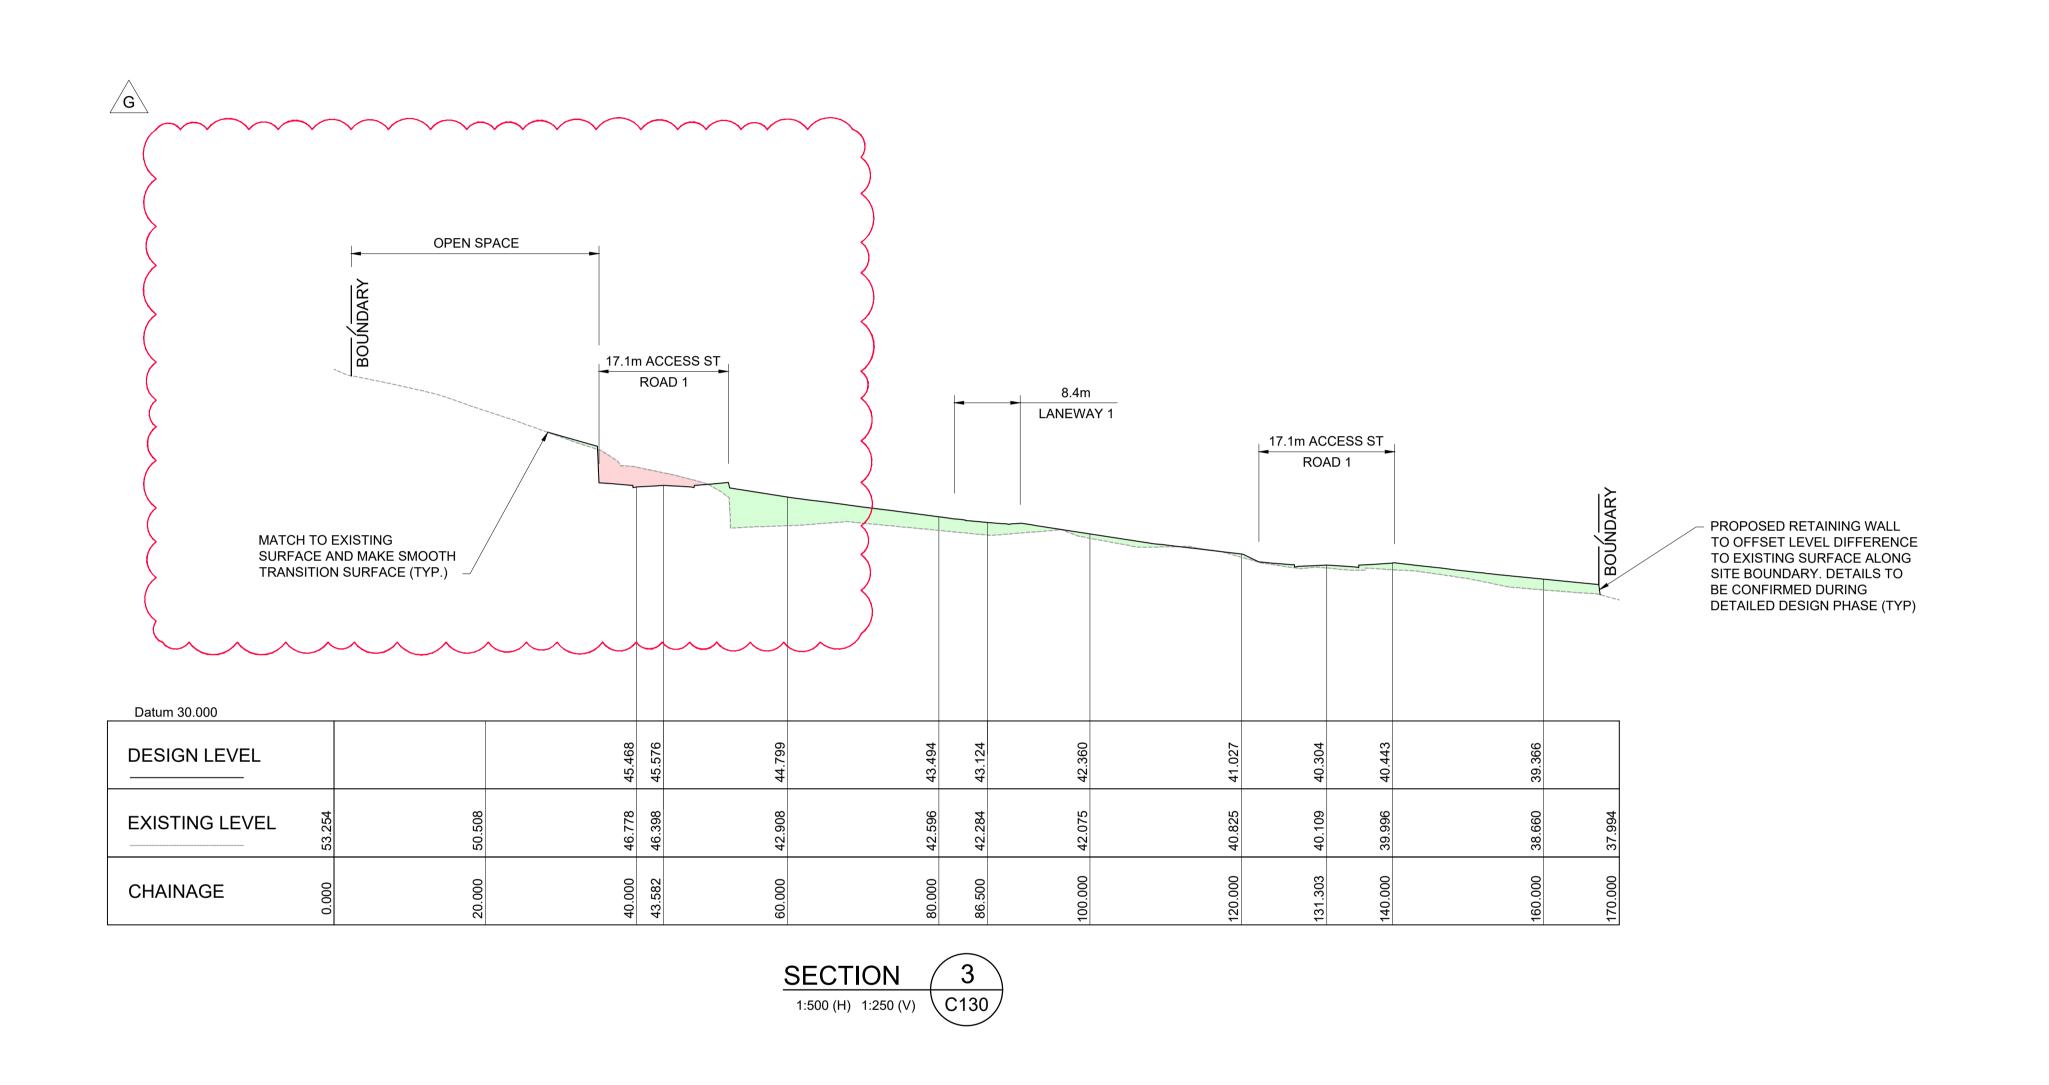

D C B Rev	19.10.23 06.09.23 Date	RE-ISSUED FOR DA  ISSUED FOR DA  Description	MRN MRN Drawn	DR DR Appr
С				
	19.10.23	RE-ISSUED FOR DA	MRN	DR
D				
	10.05.24	RE-ISSUED FOR DA	GAP	DR
Е	14.05.24	RE-ISSUED FOR DA	VT	DR
F	03.10.24	RE-ISSUED FOR DA	VT	DR
G	09.04.24	RE-ISSUED FOR DA (OPEN SPACE)	VT	DR



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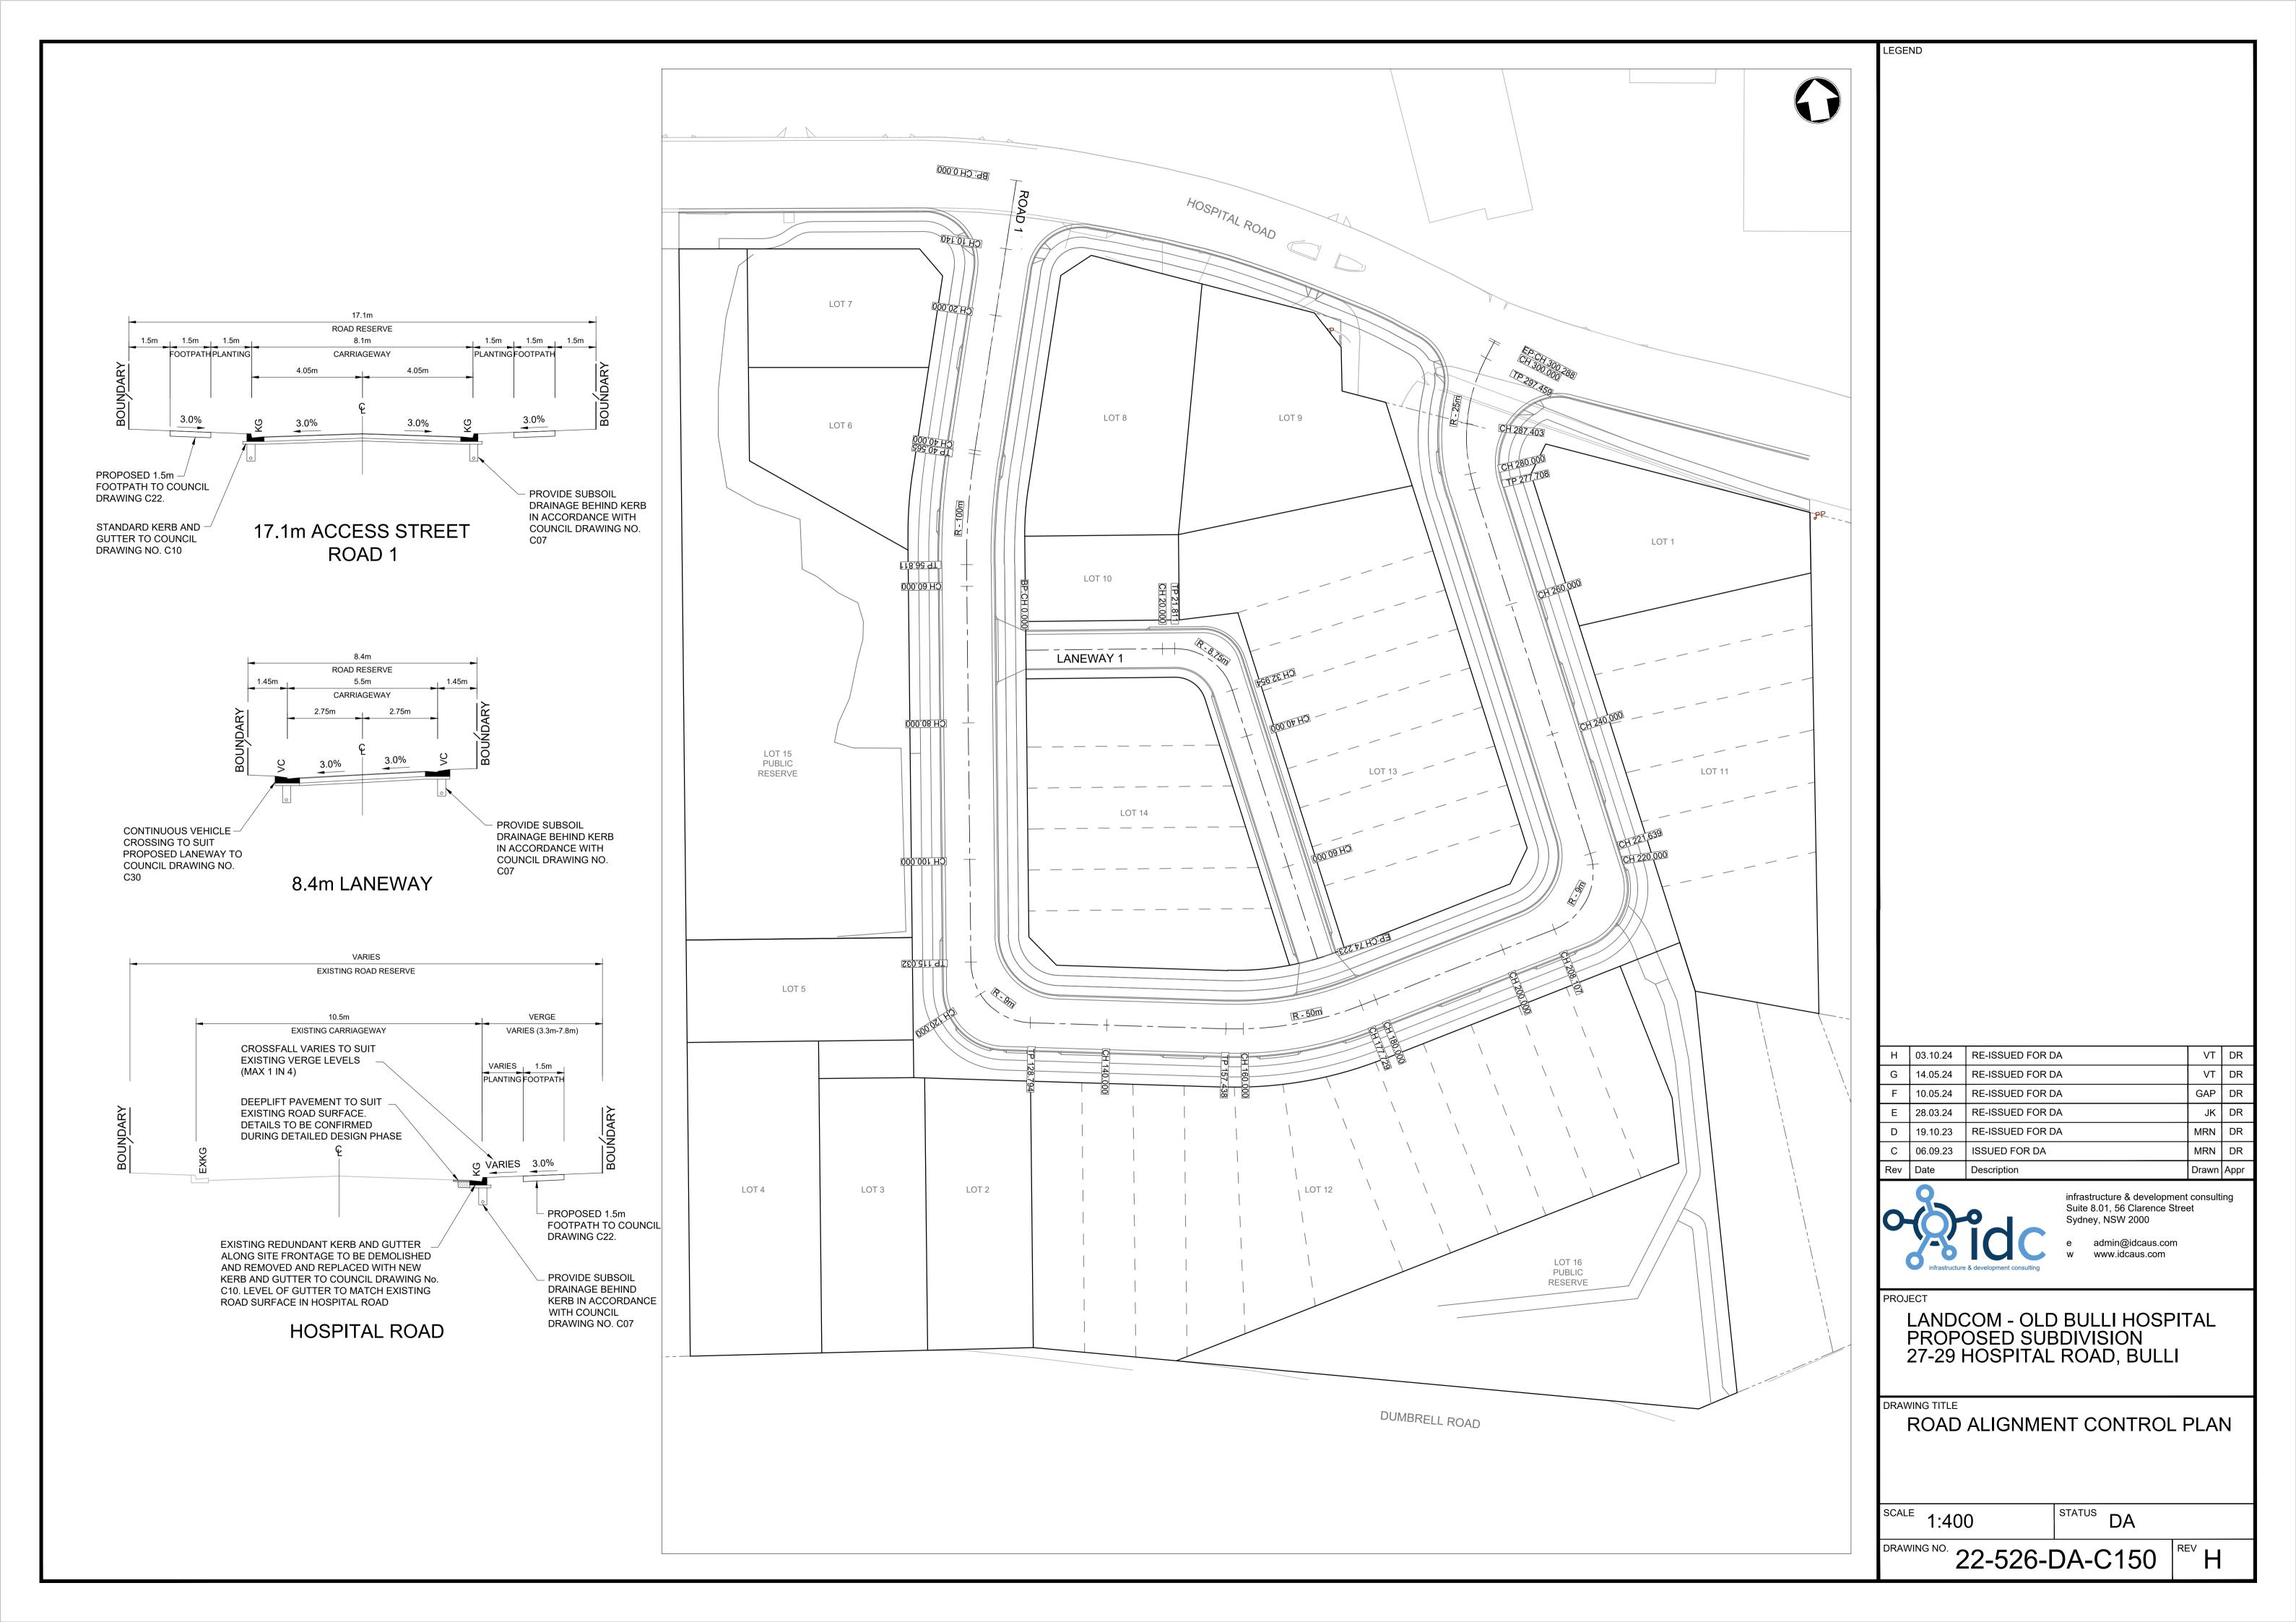
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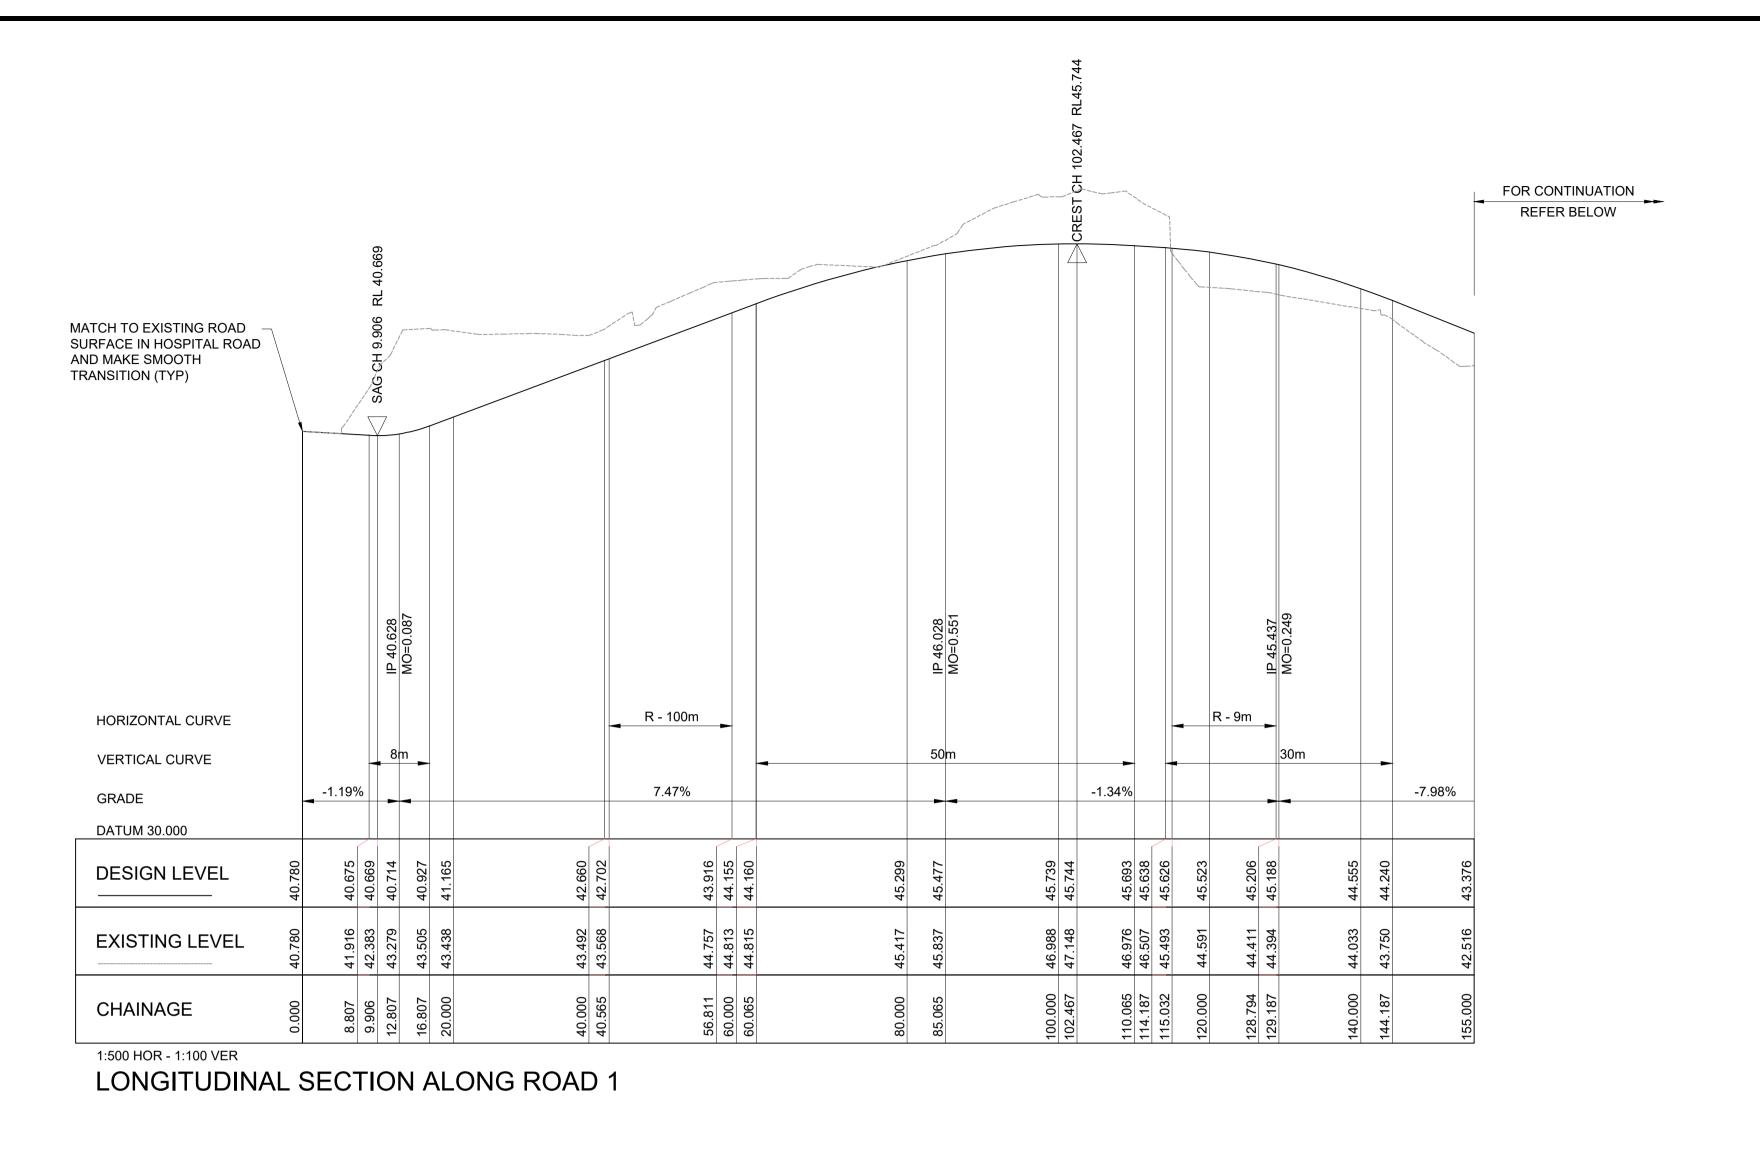
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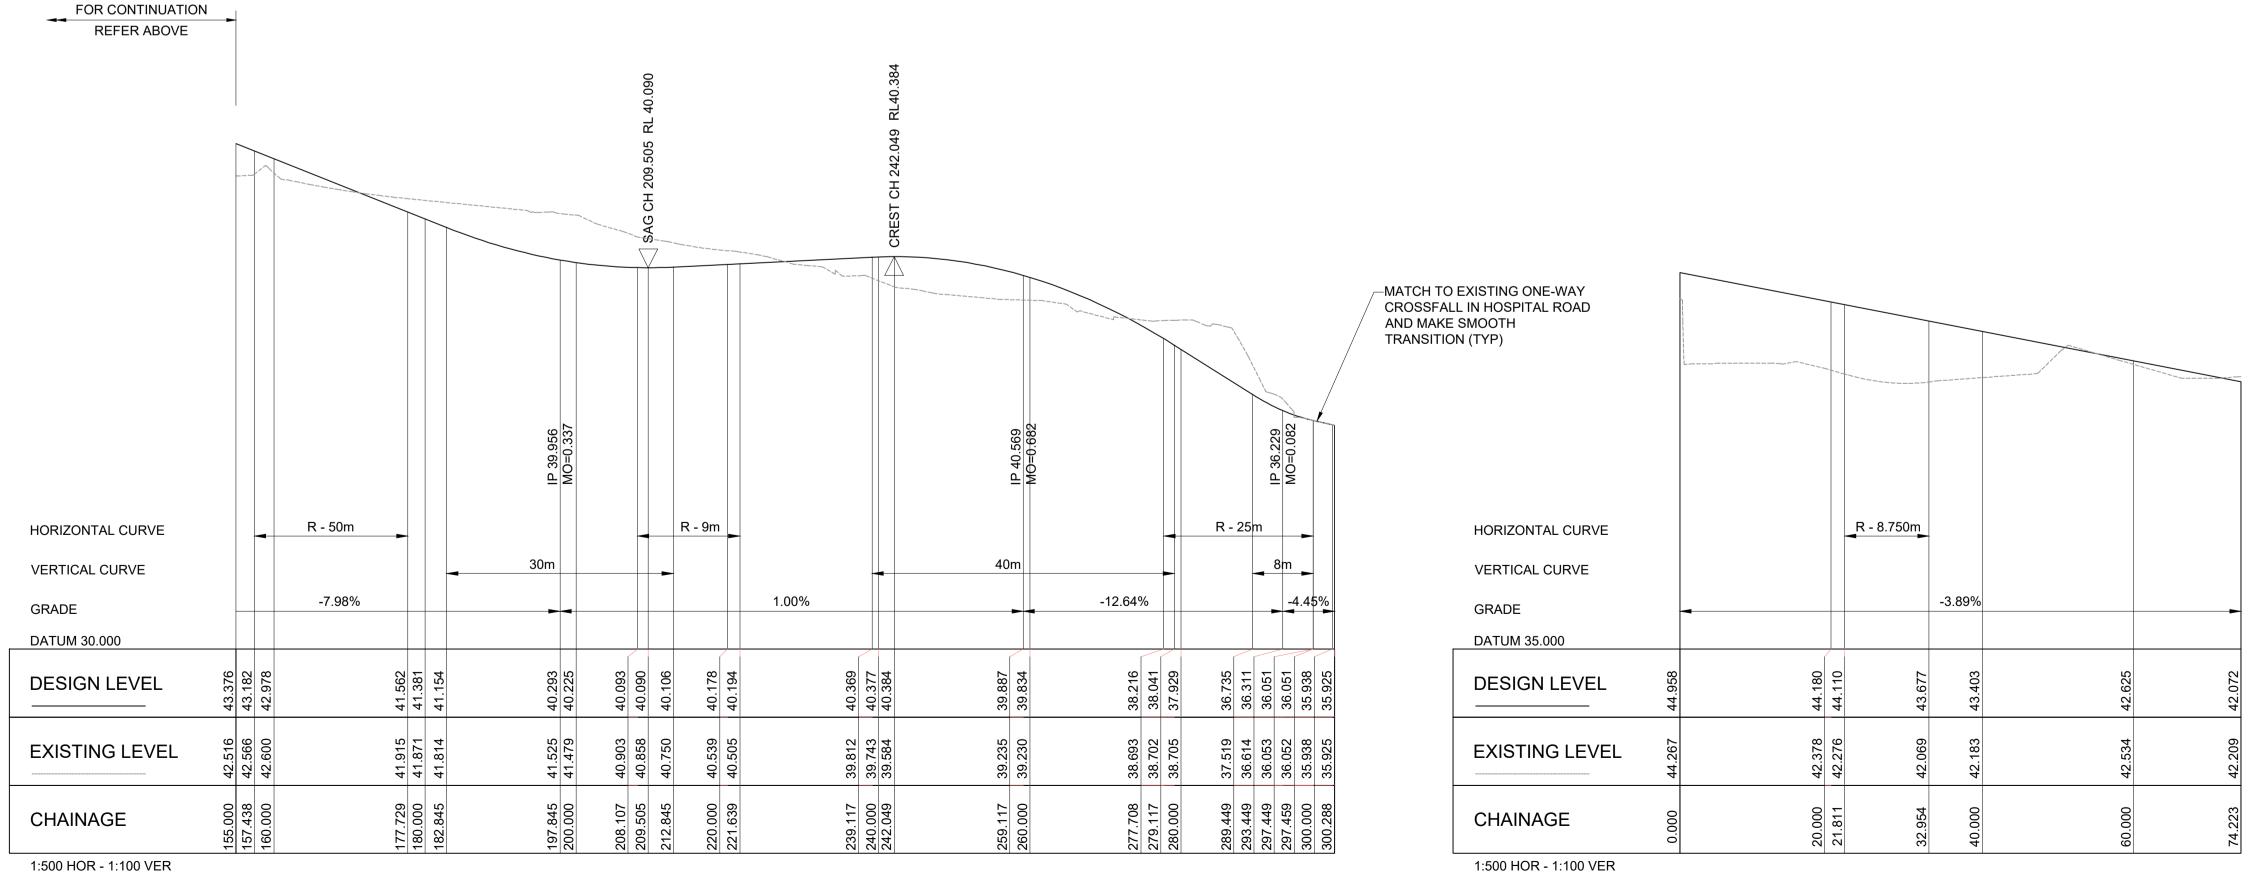
SITE SECTIONS SHEET 2

SCALE 1:500, 1:250 STATUS DA

DRAWING NO. 22-526-DA-C136 REV G







LONGITUDINAL SECTION ALONG ROAD 1 (CONTINUED)

LONGITUDINAL SECTION ALONG LANEWAY 1

G 03.10.24 RE-ISSUED FOR DA RE-ISSUED FOR DA GAP DR E 10.05.24 RE-ISSUED FOR DA MRN DR D 19.10.23 RE-ISSUED FOR DA MRN DR ISSUED FOR DA 06.09.23 GAP DR 14.07.23 ISSUED FOR INFORMATION



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LEGEND

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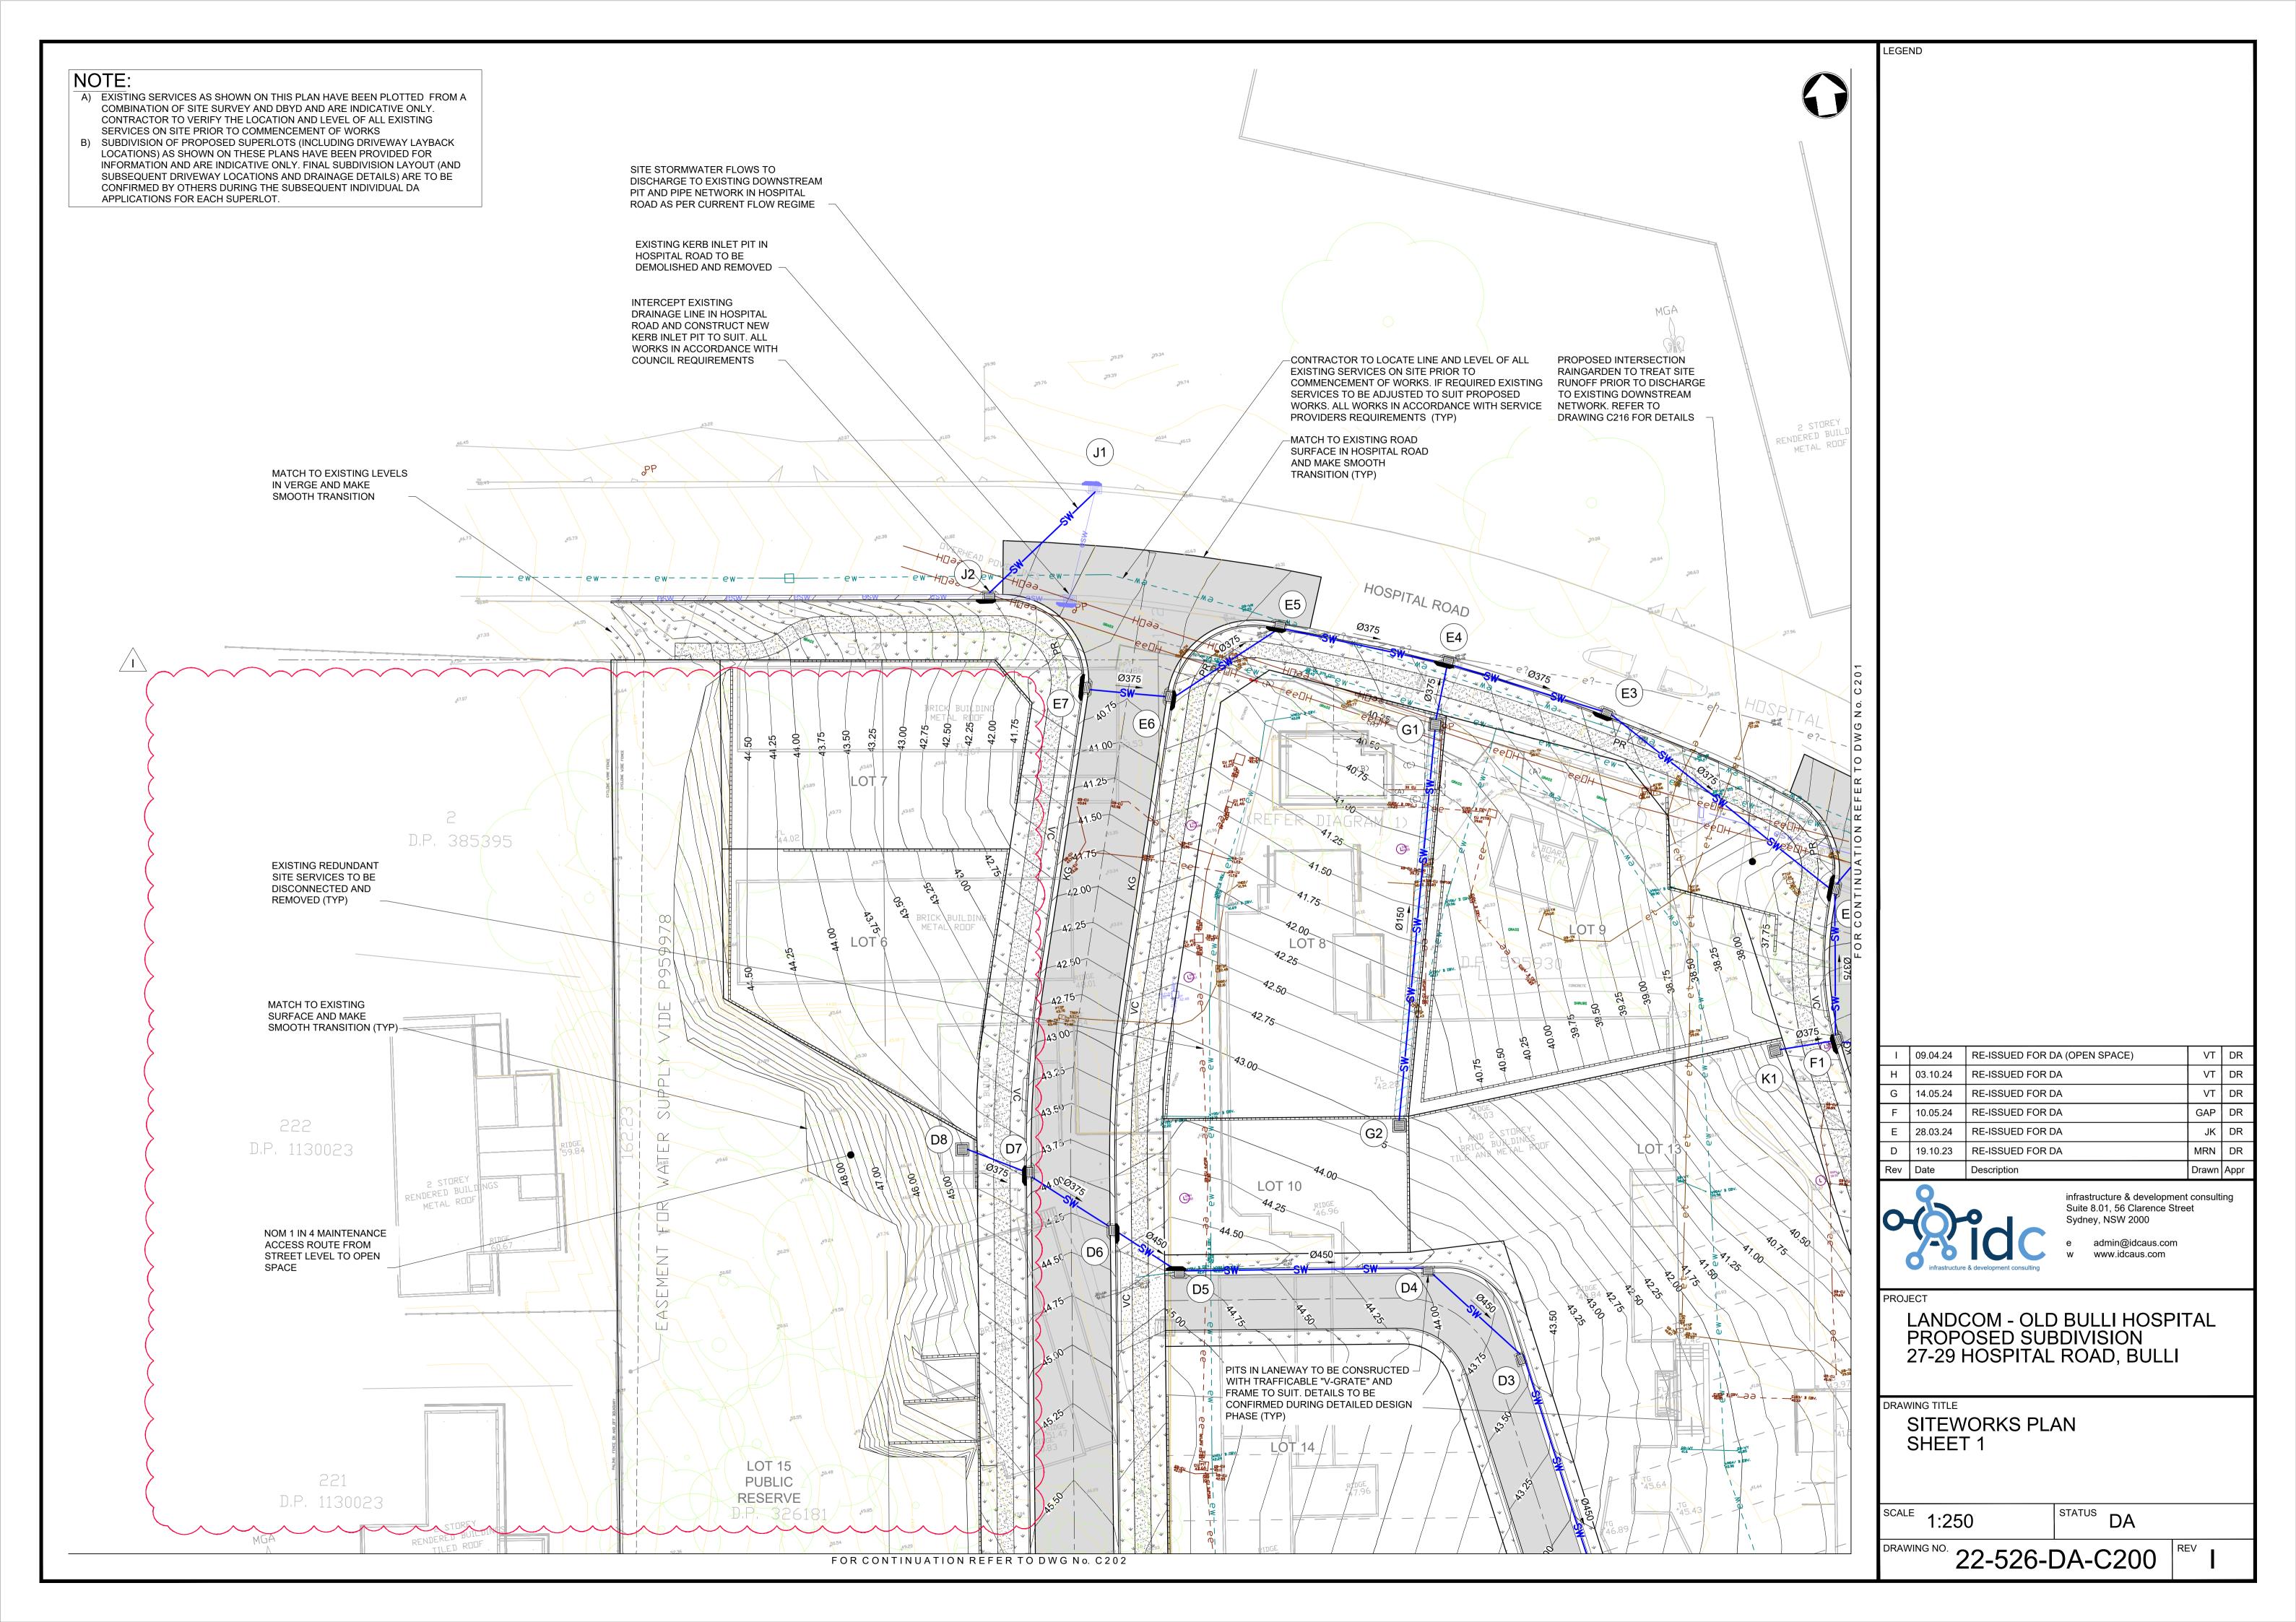
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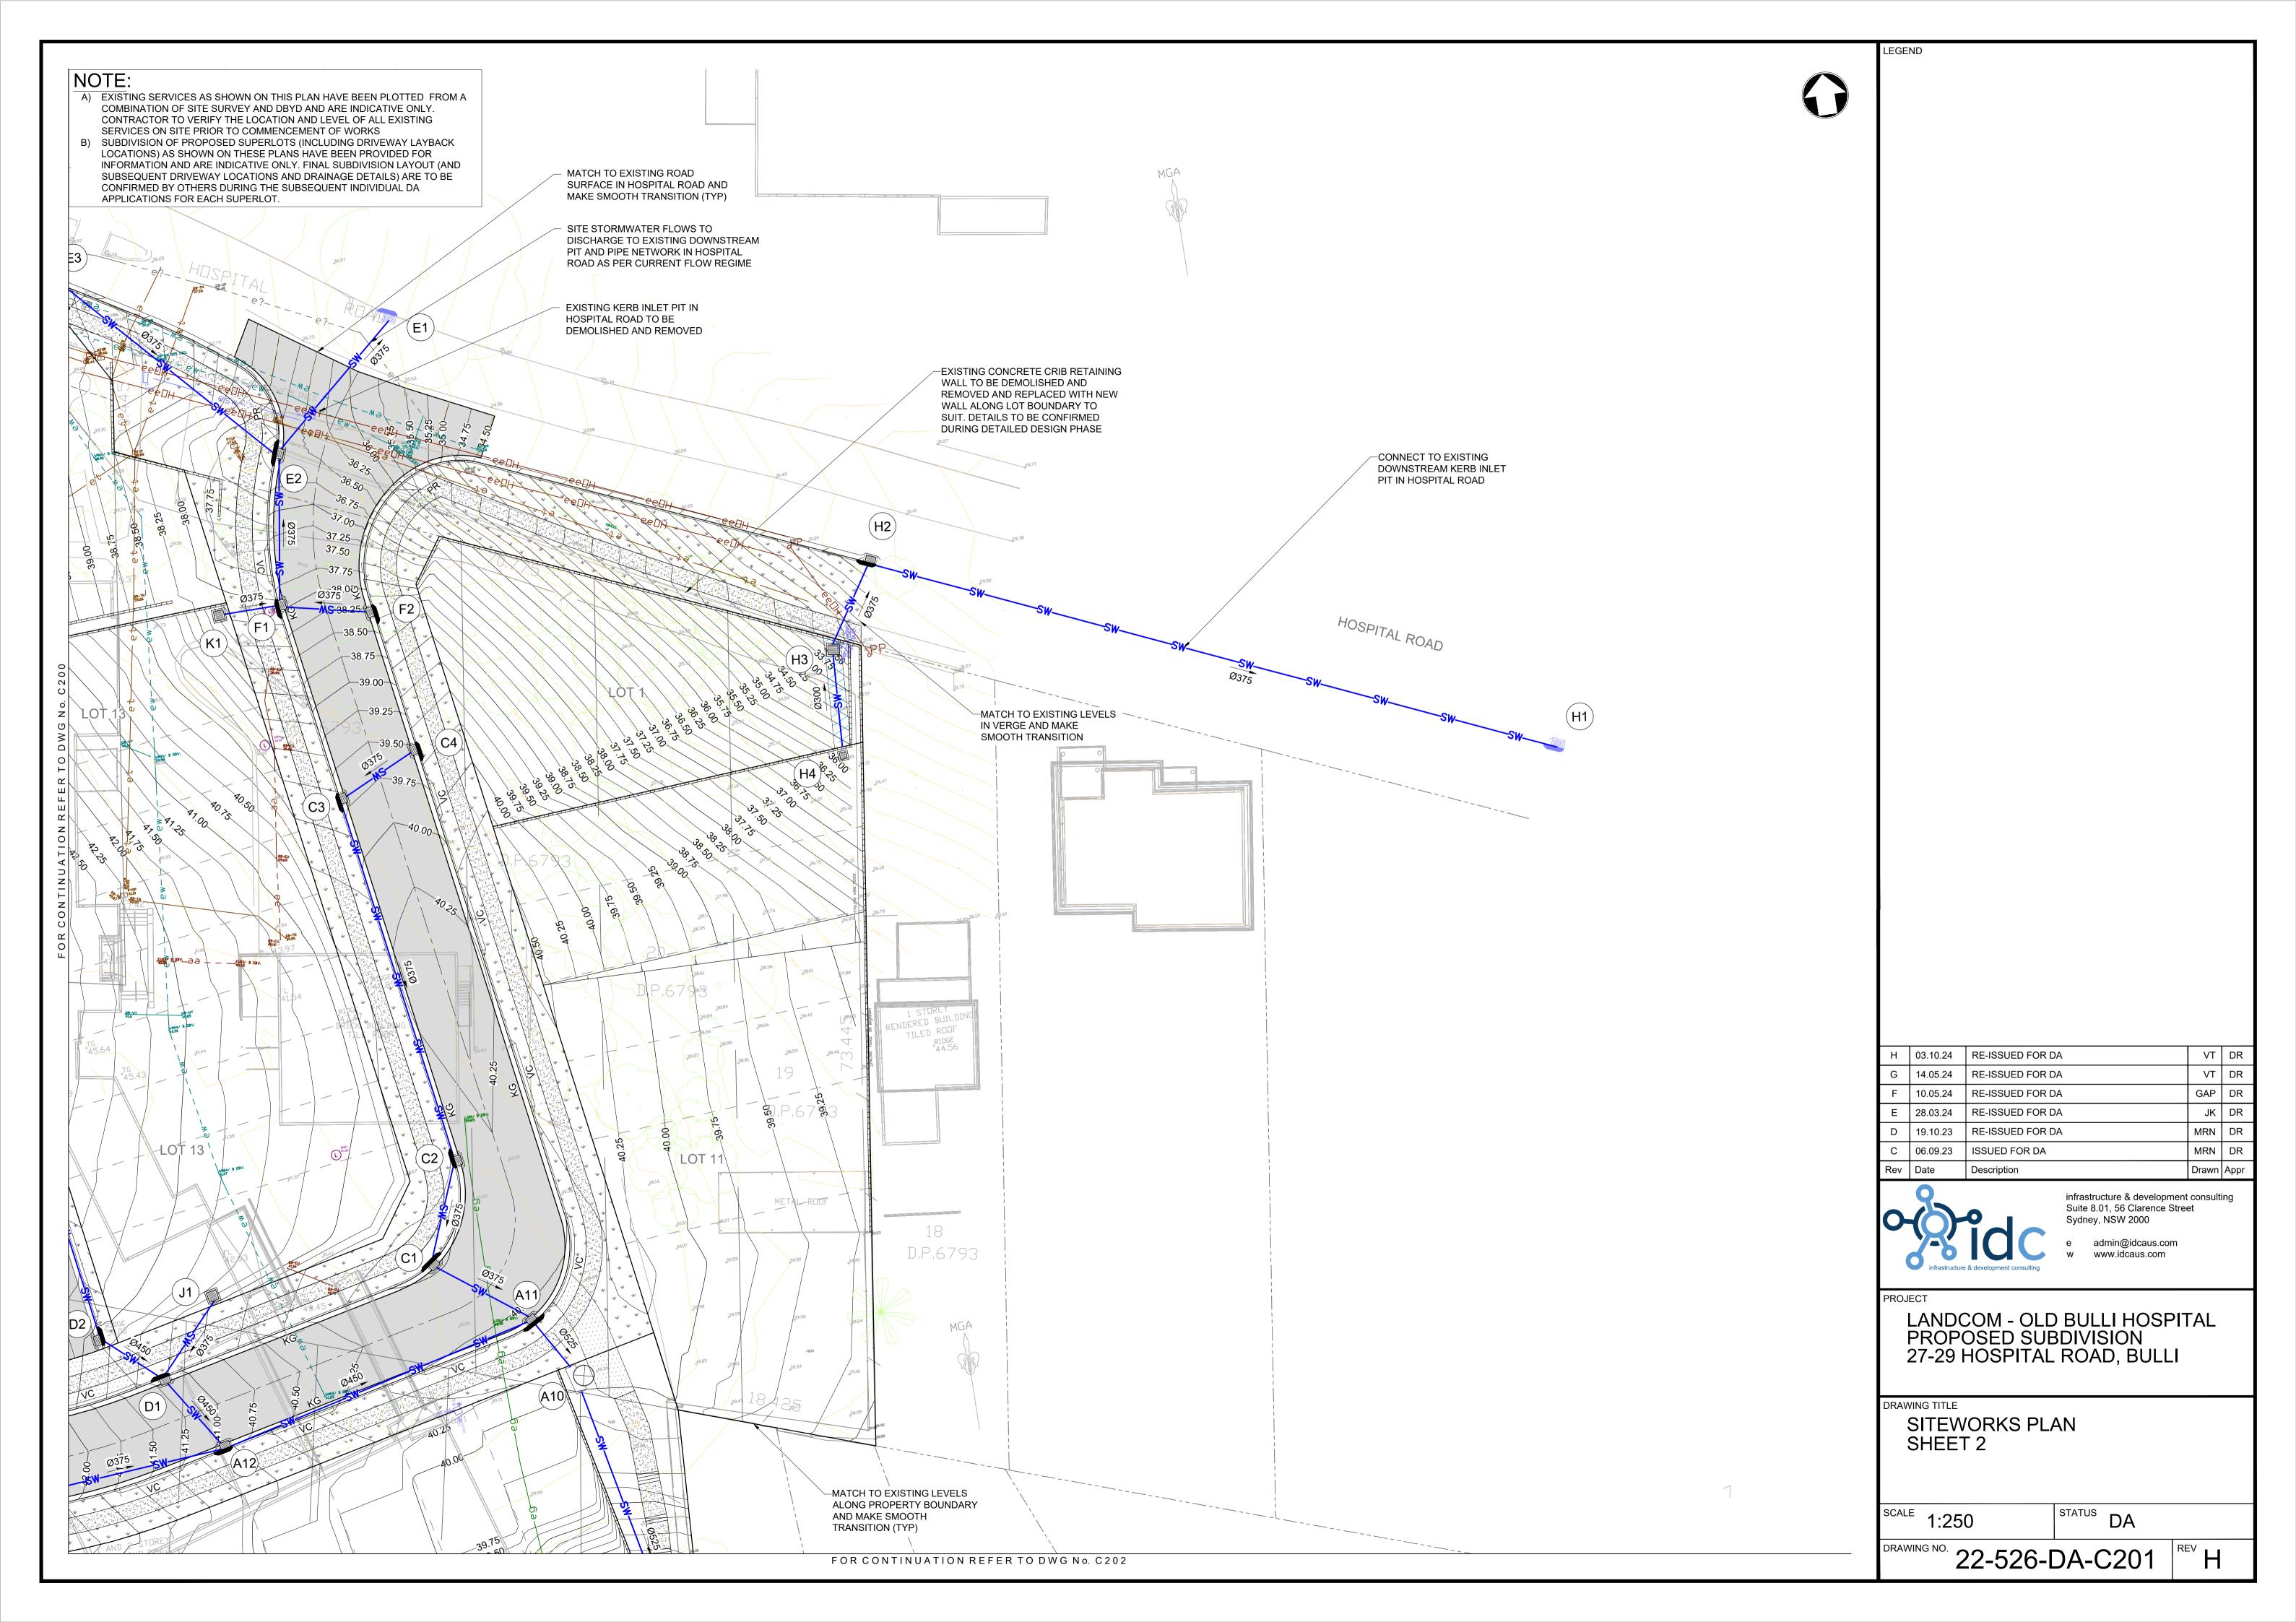
ROAD LONGITUDINAL SECTIONS


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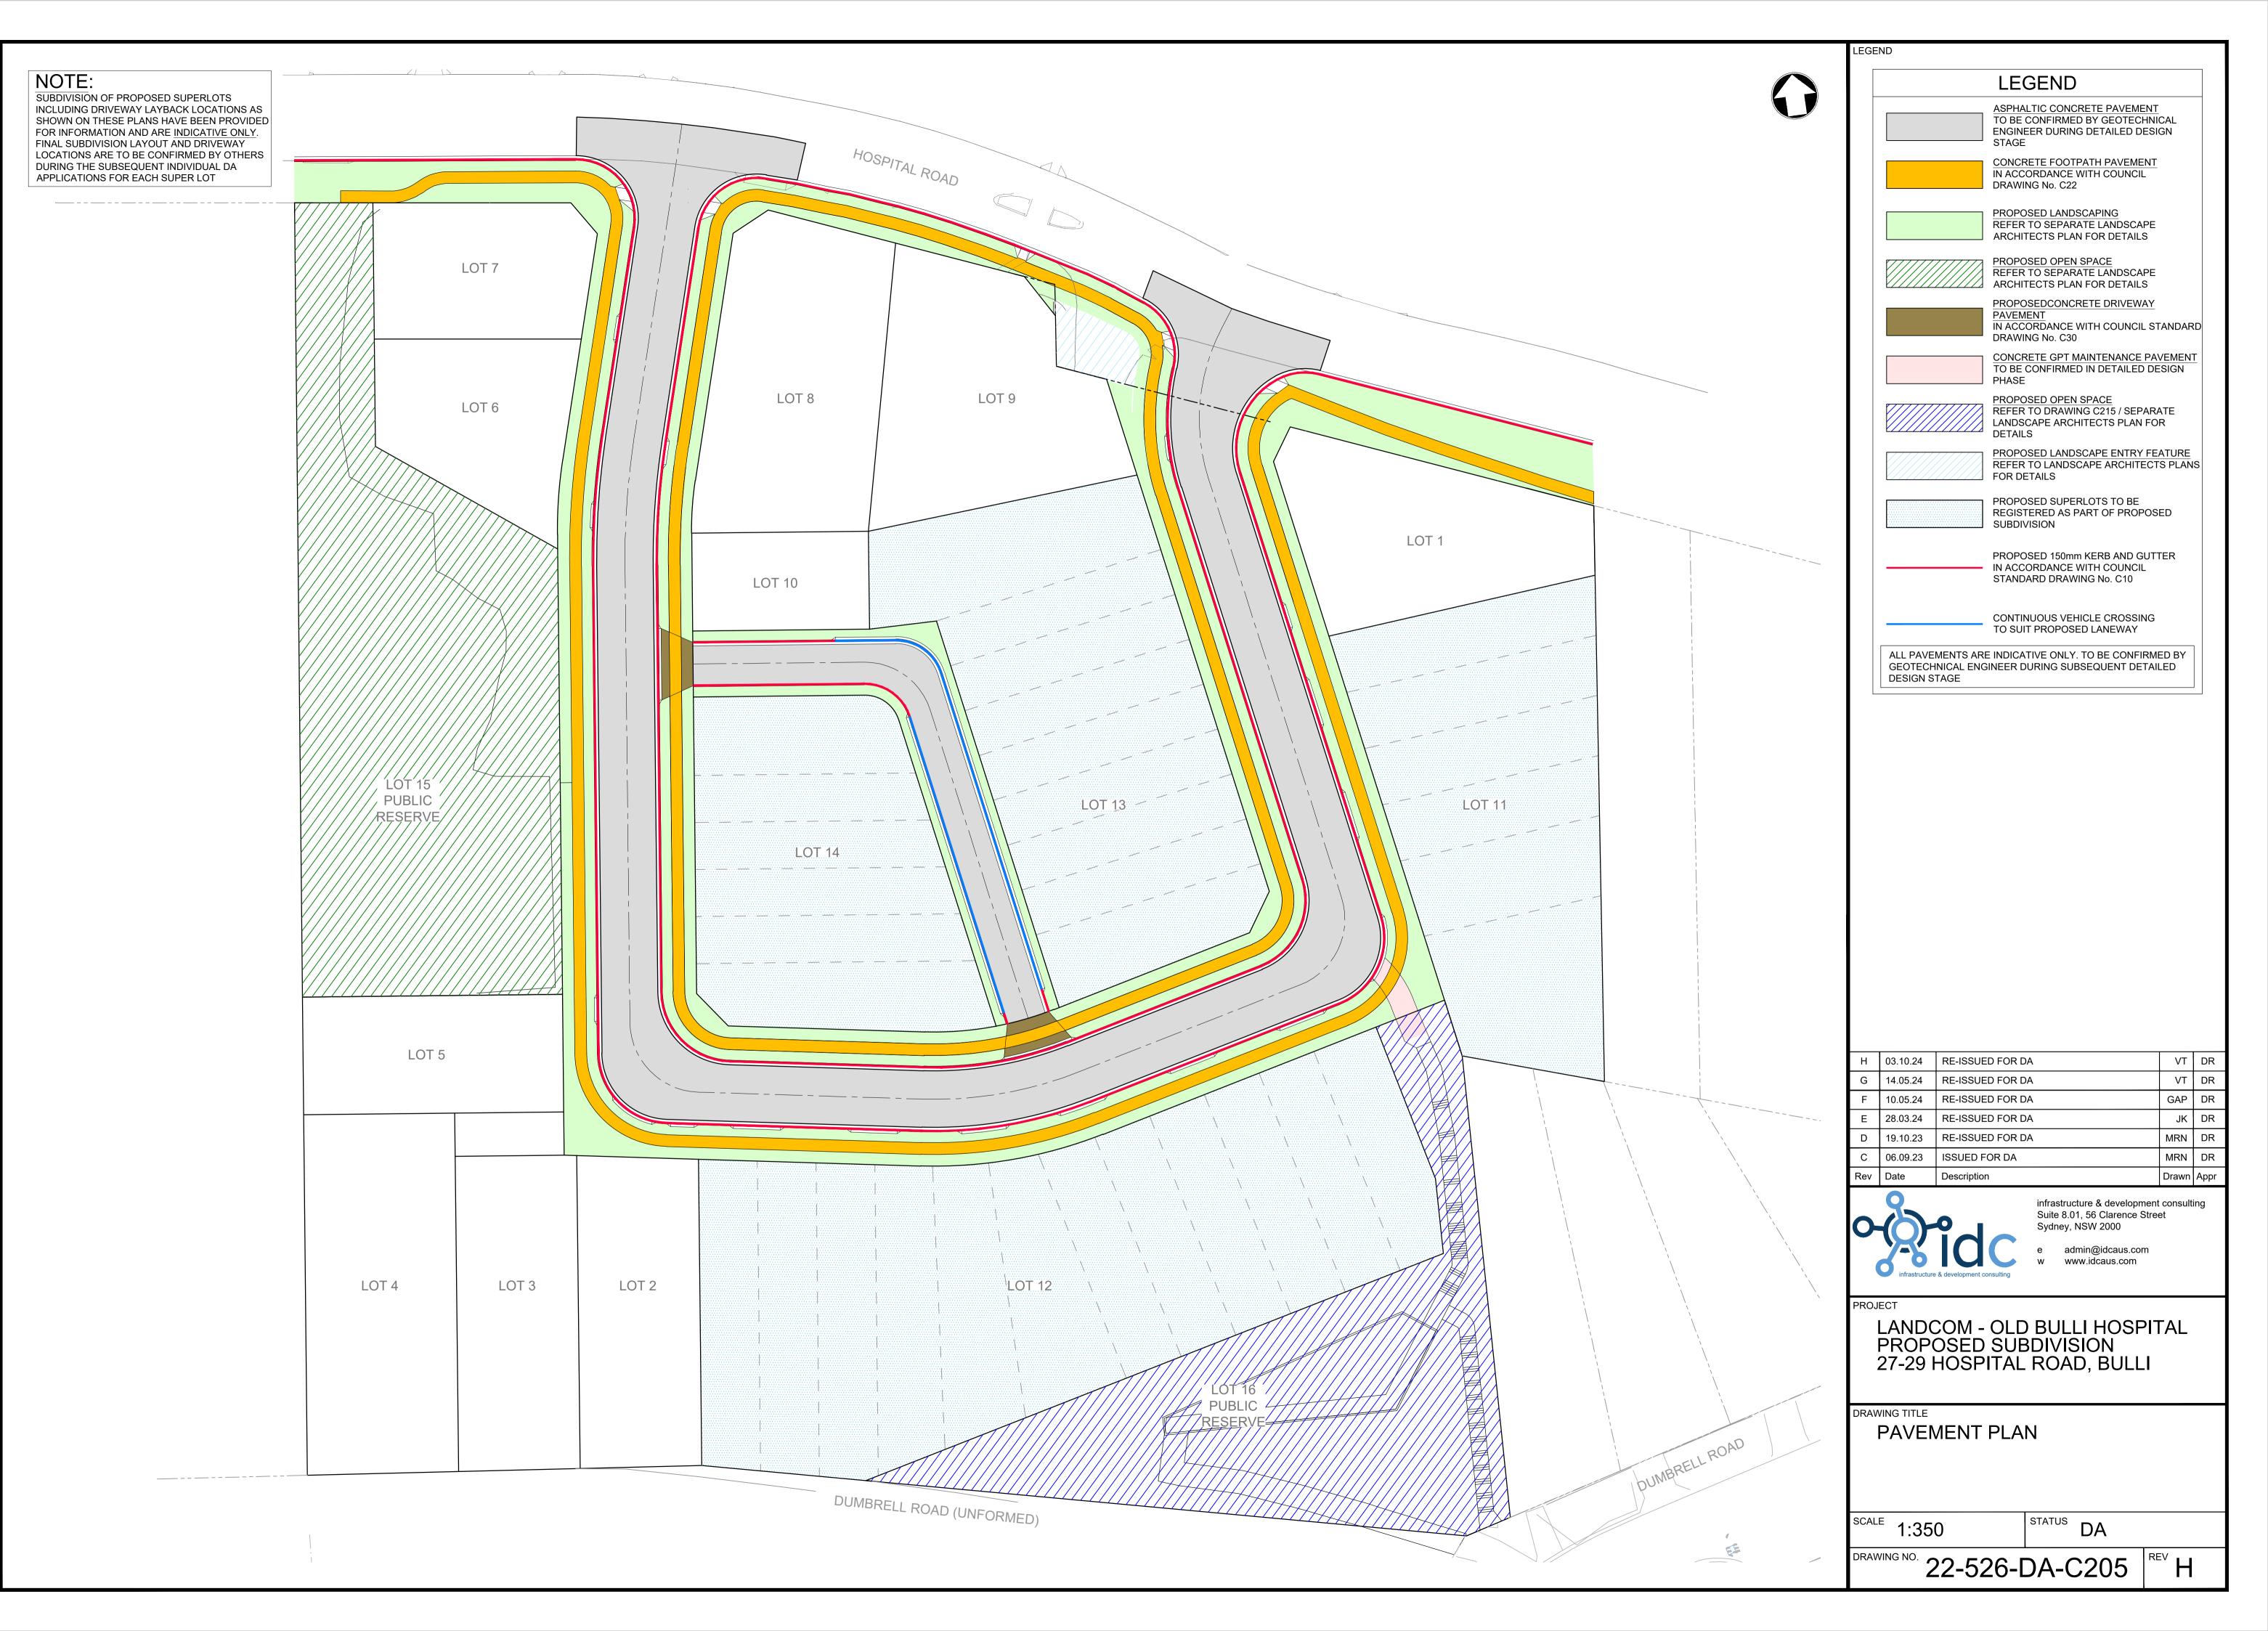
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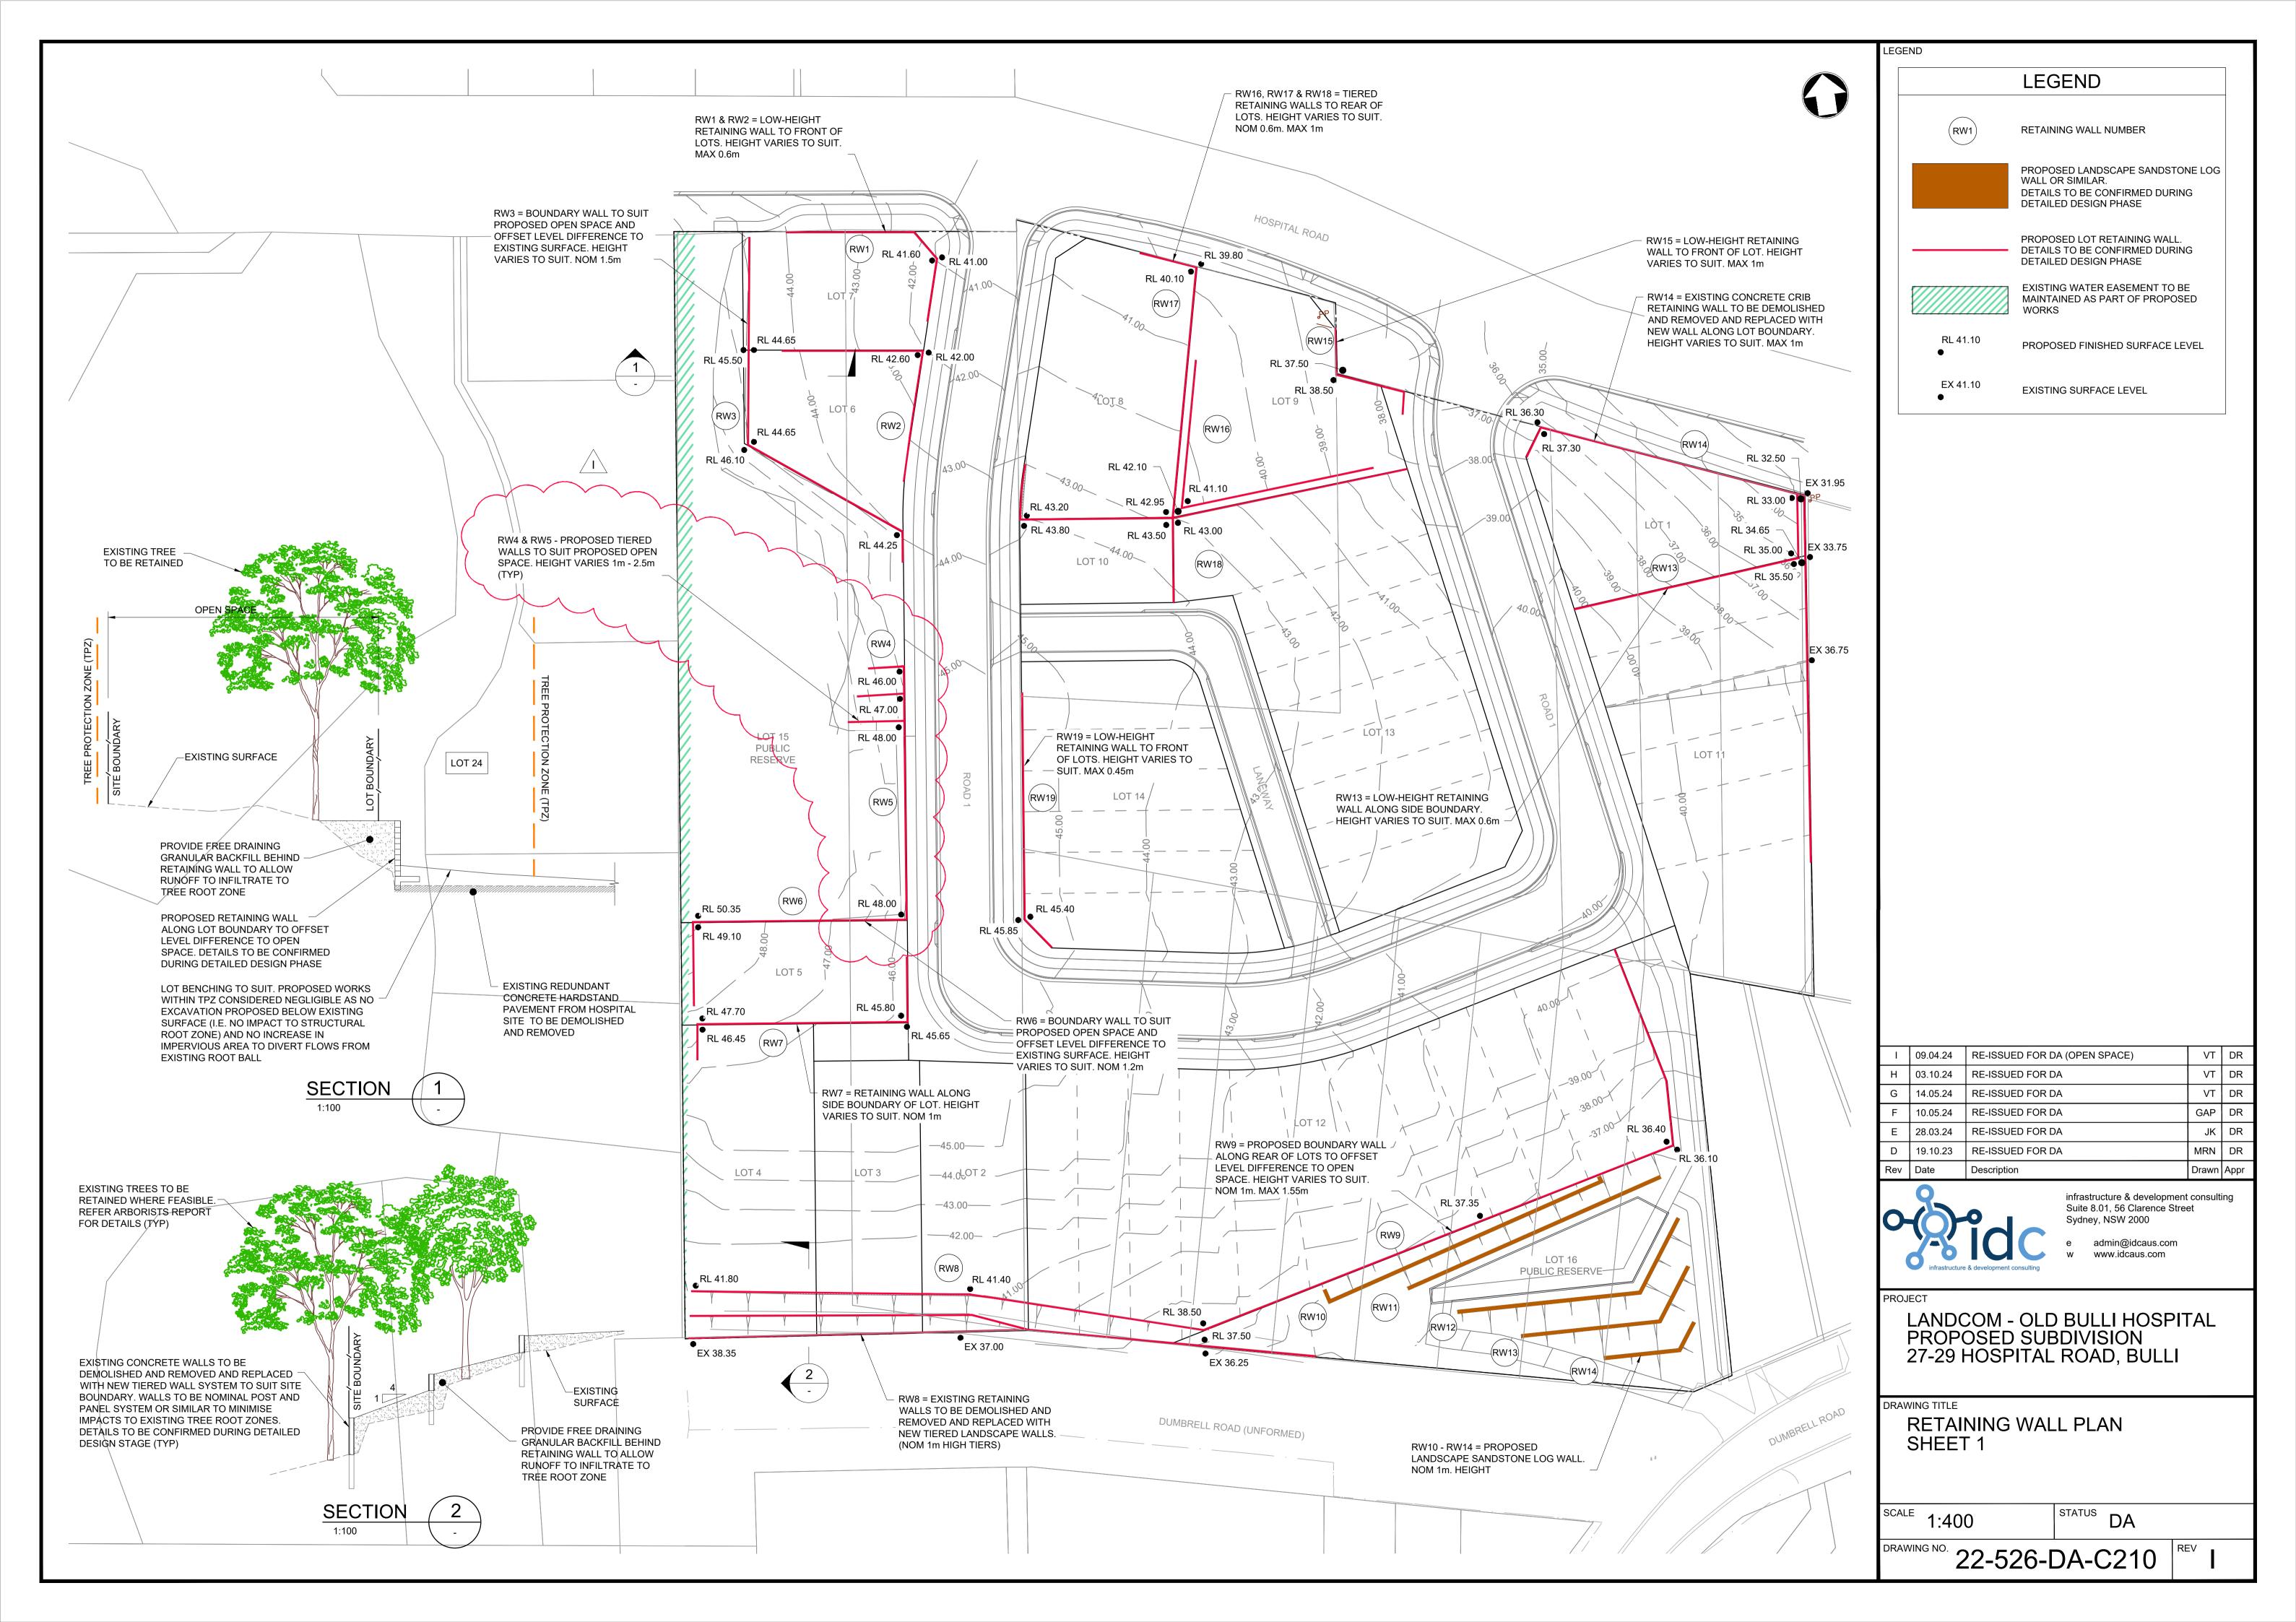
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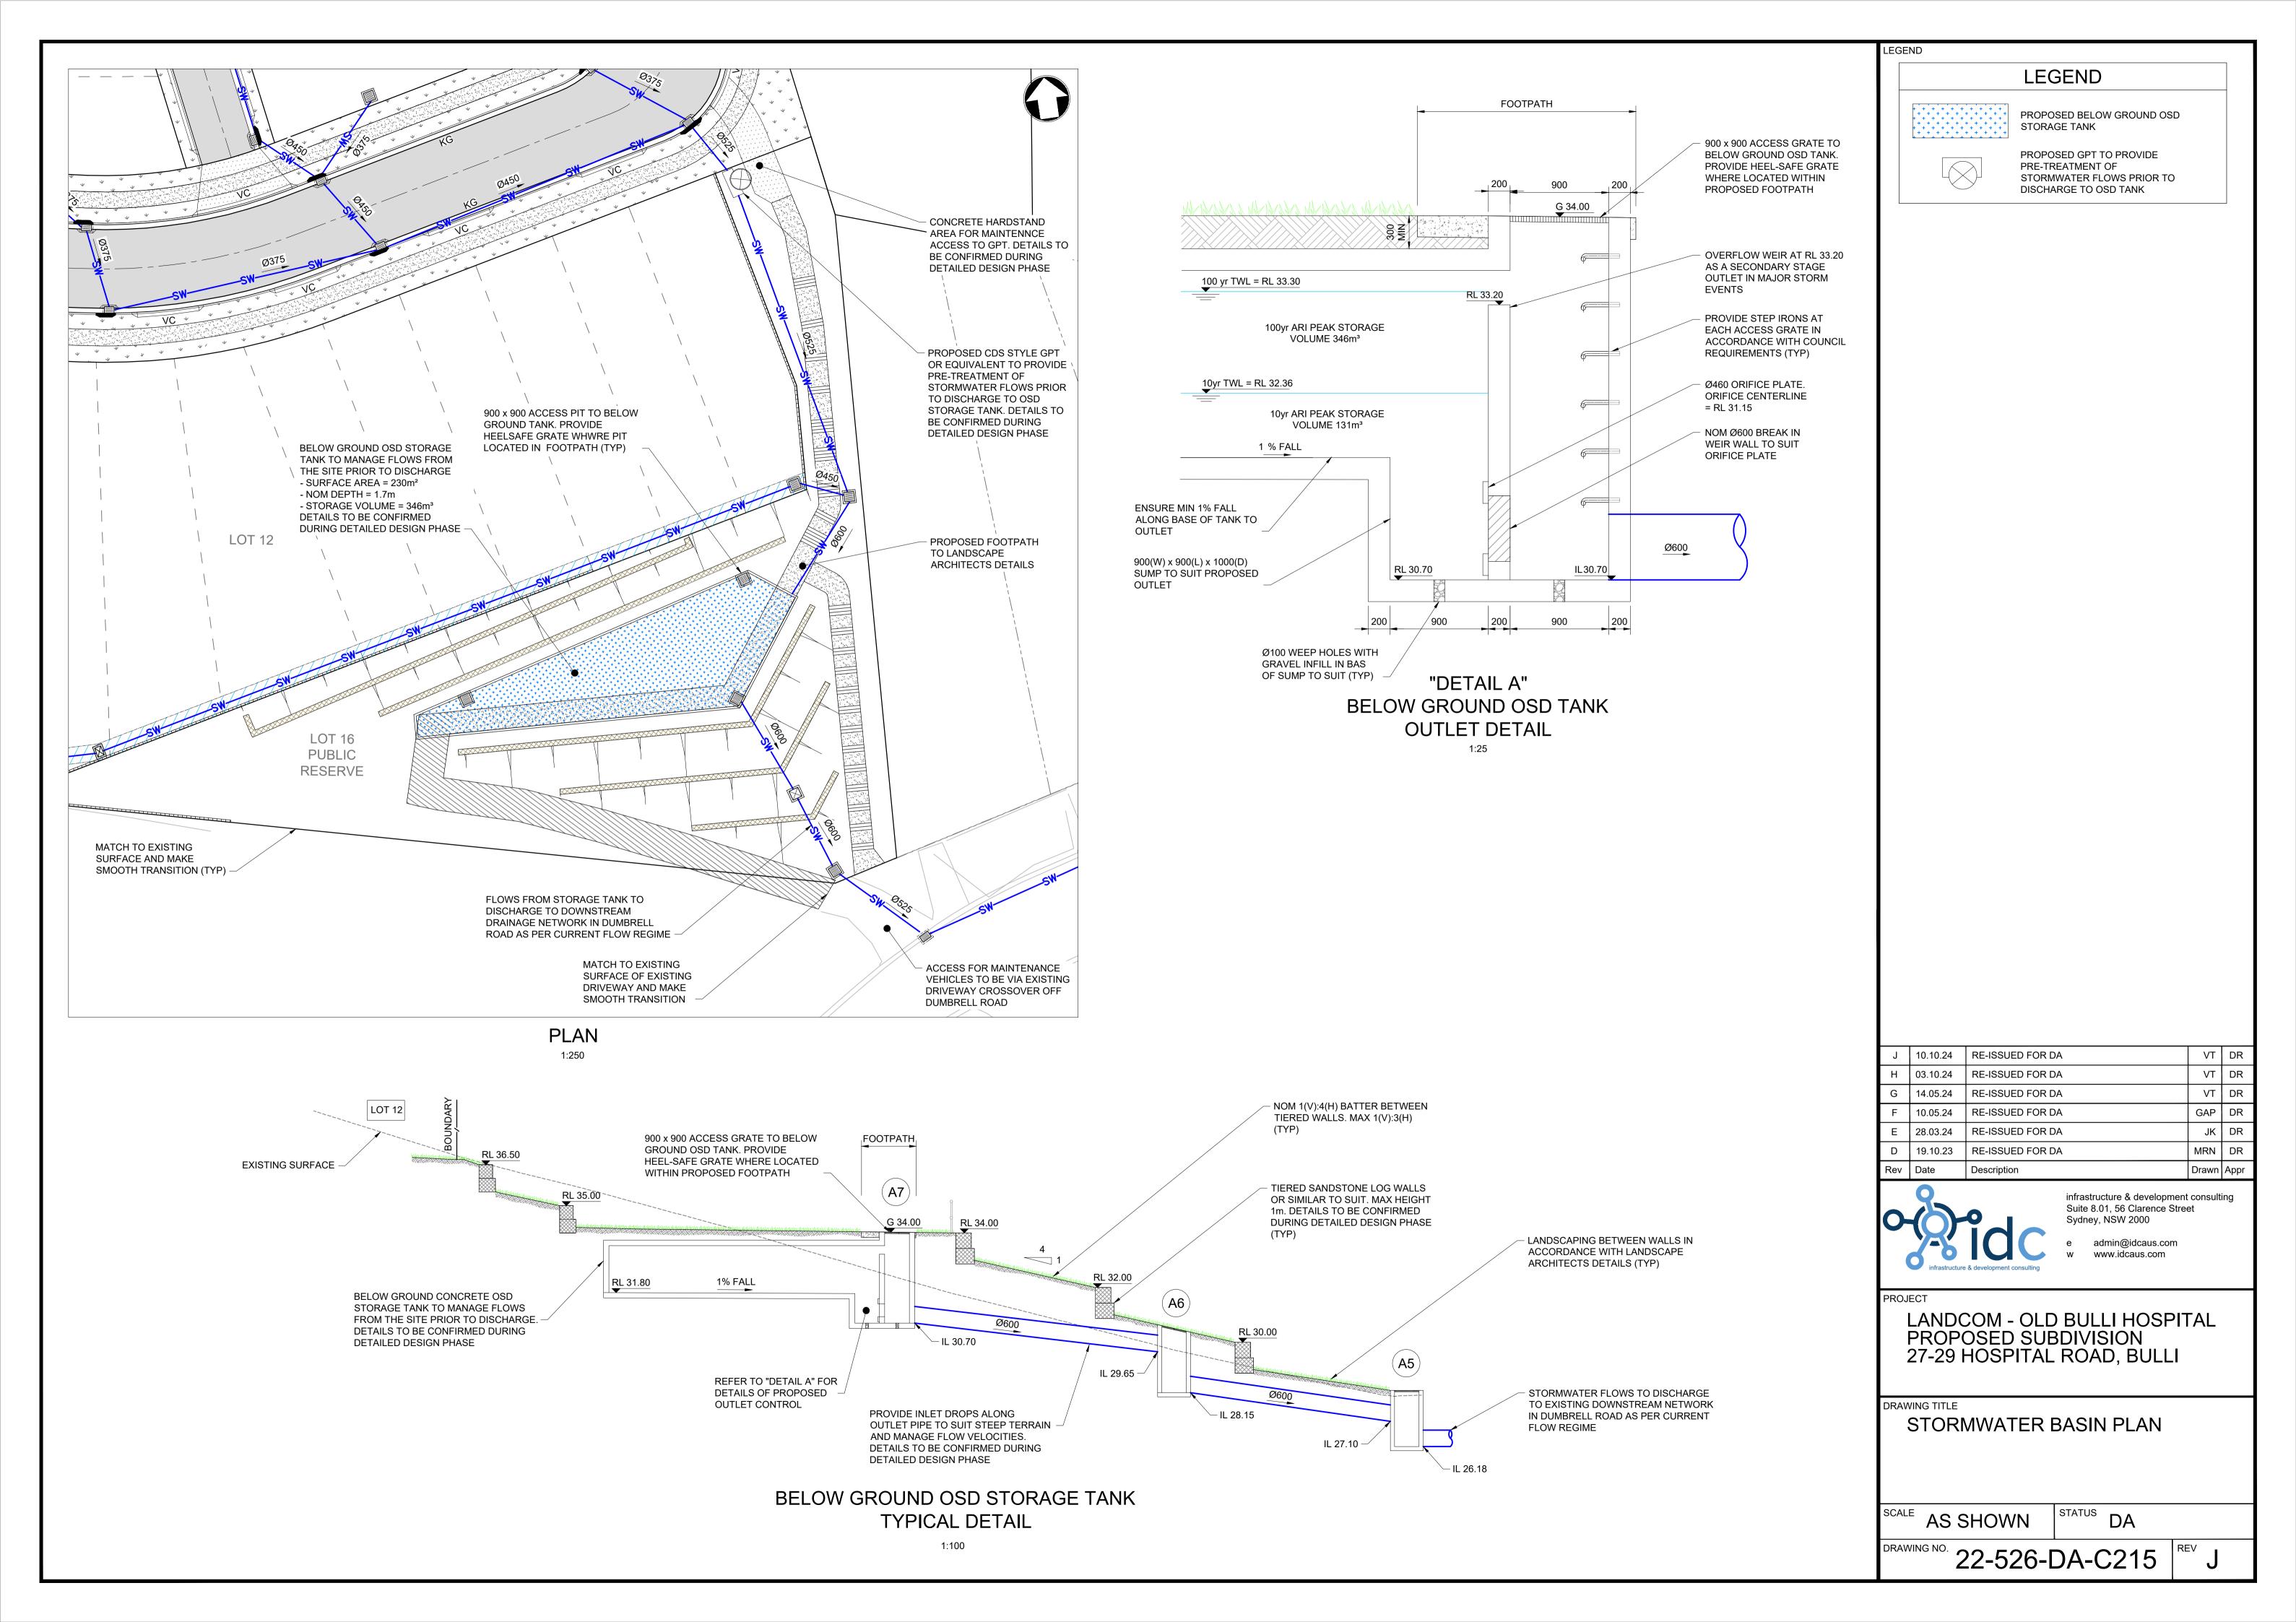











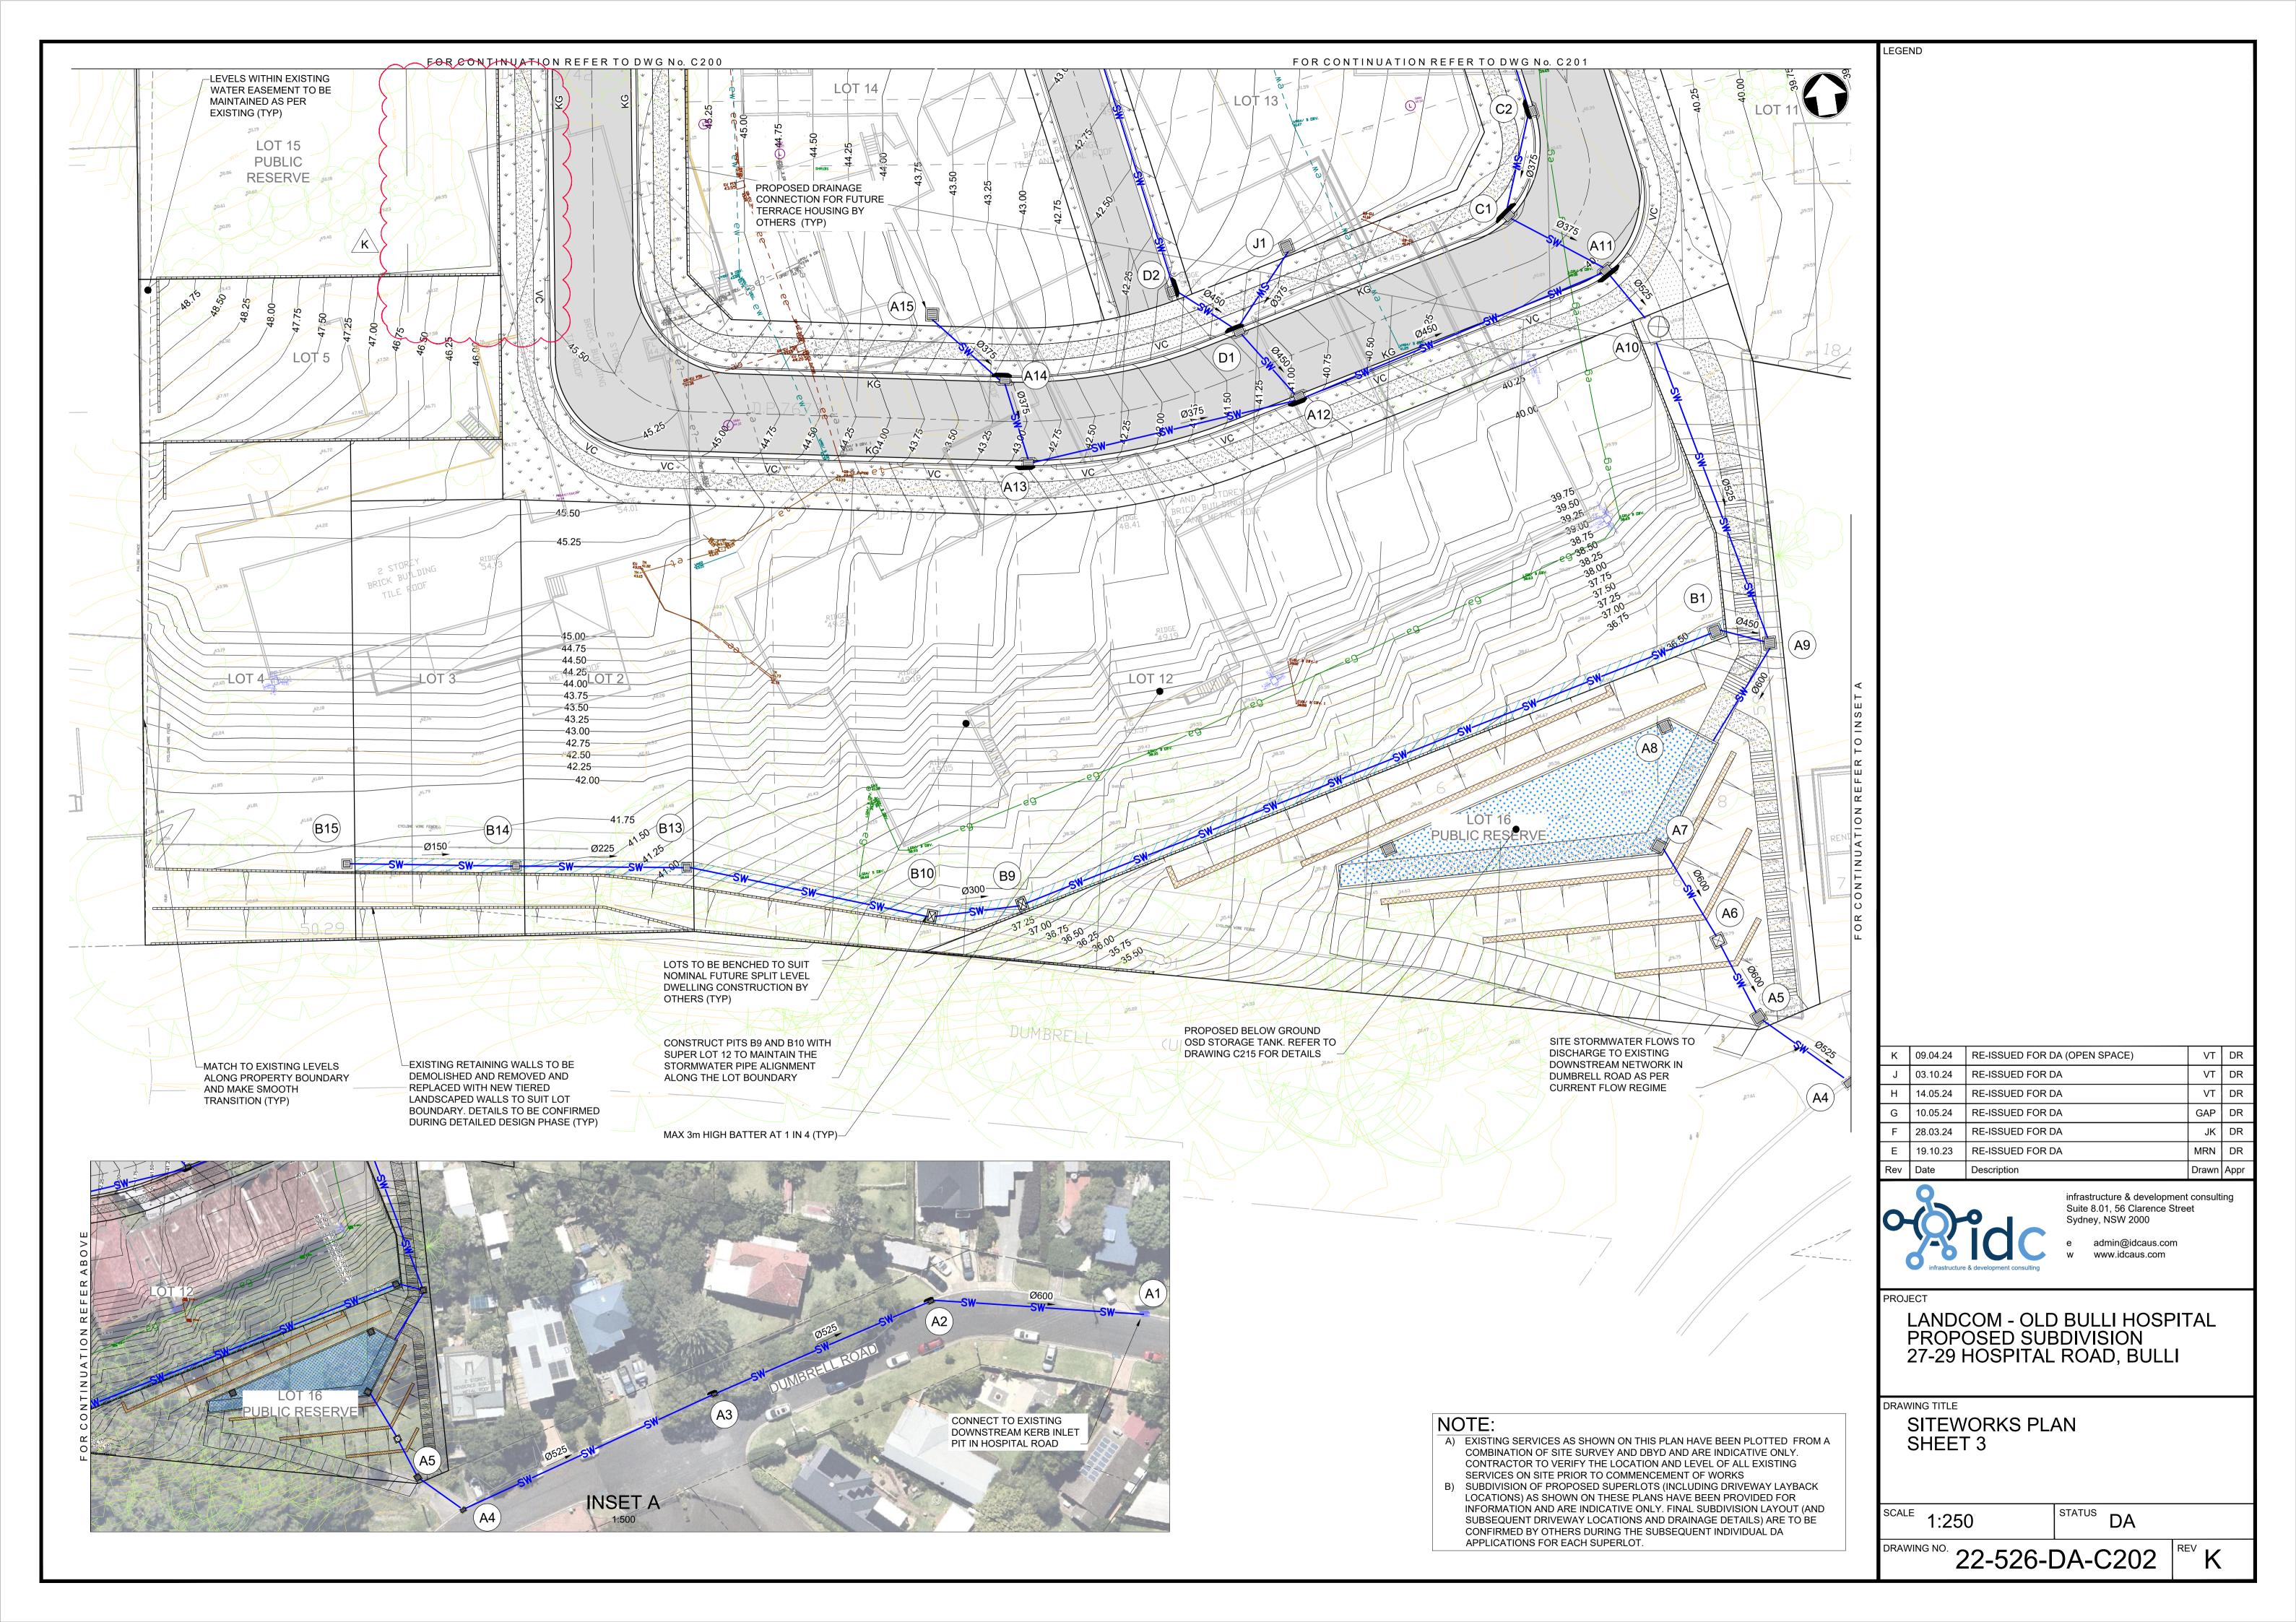

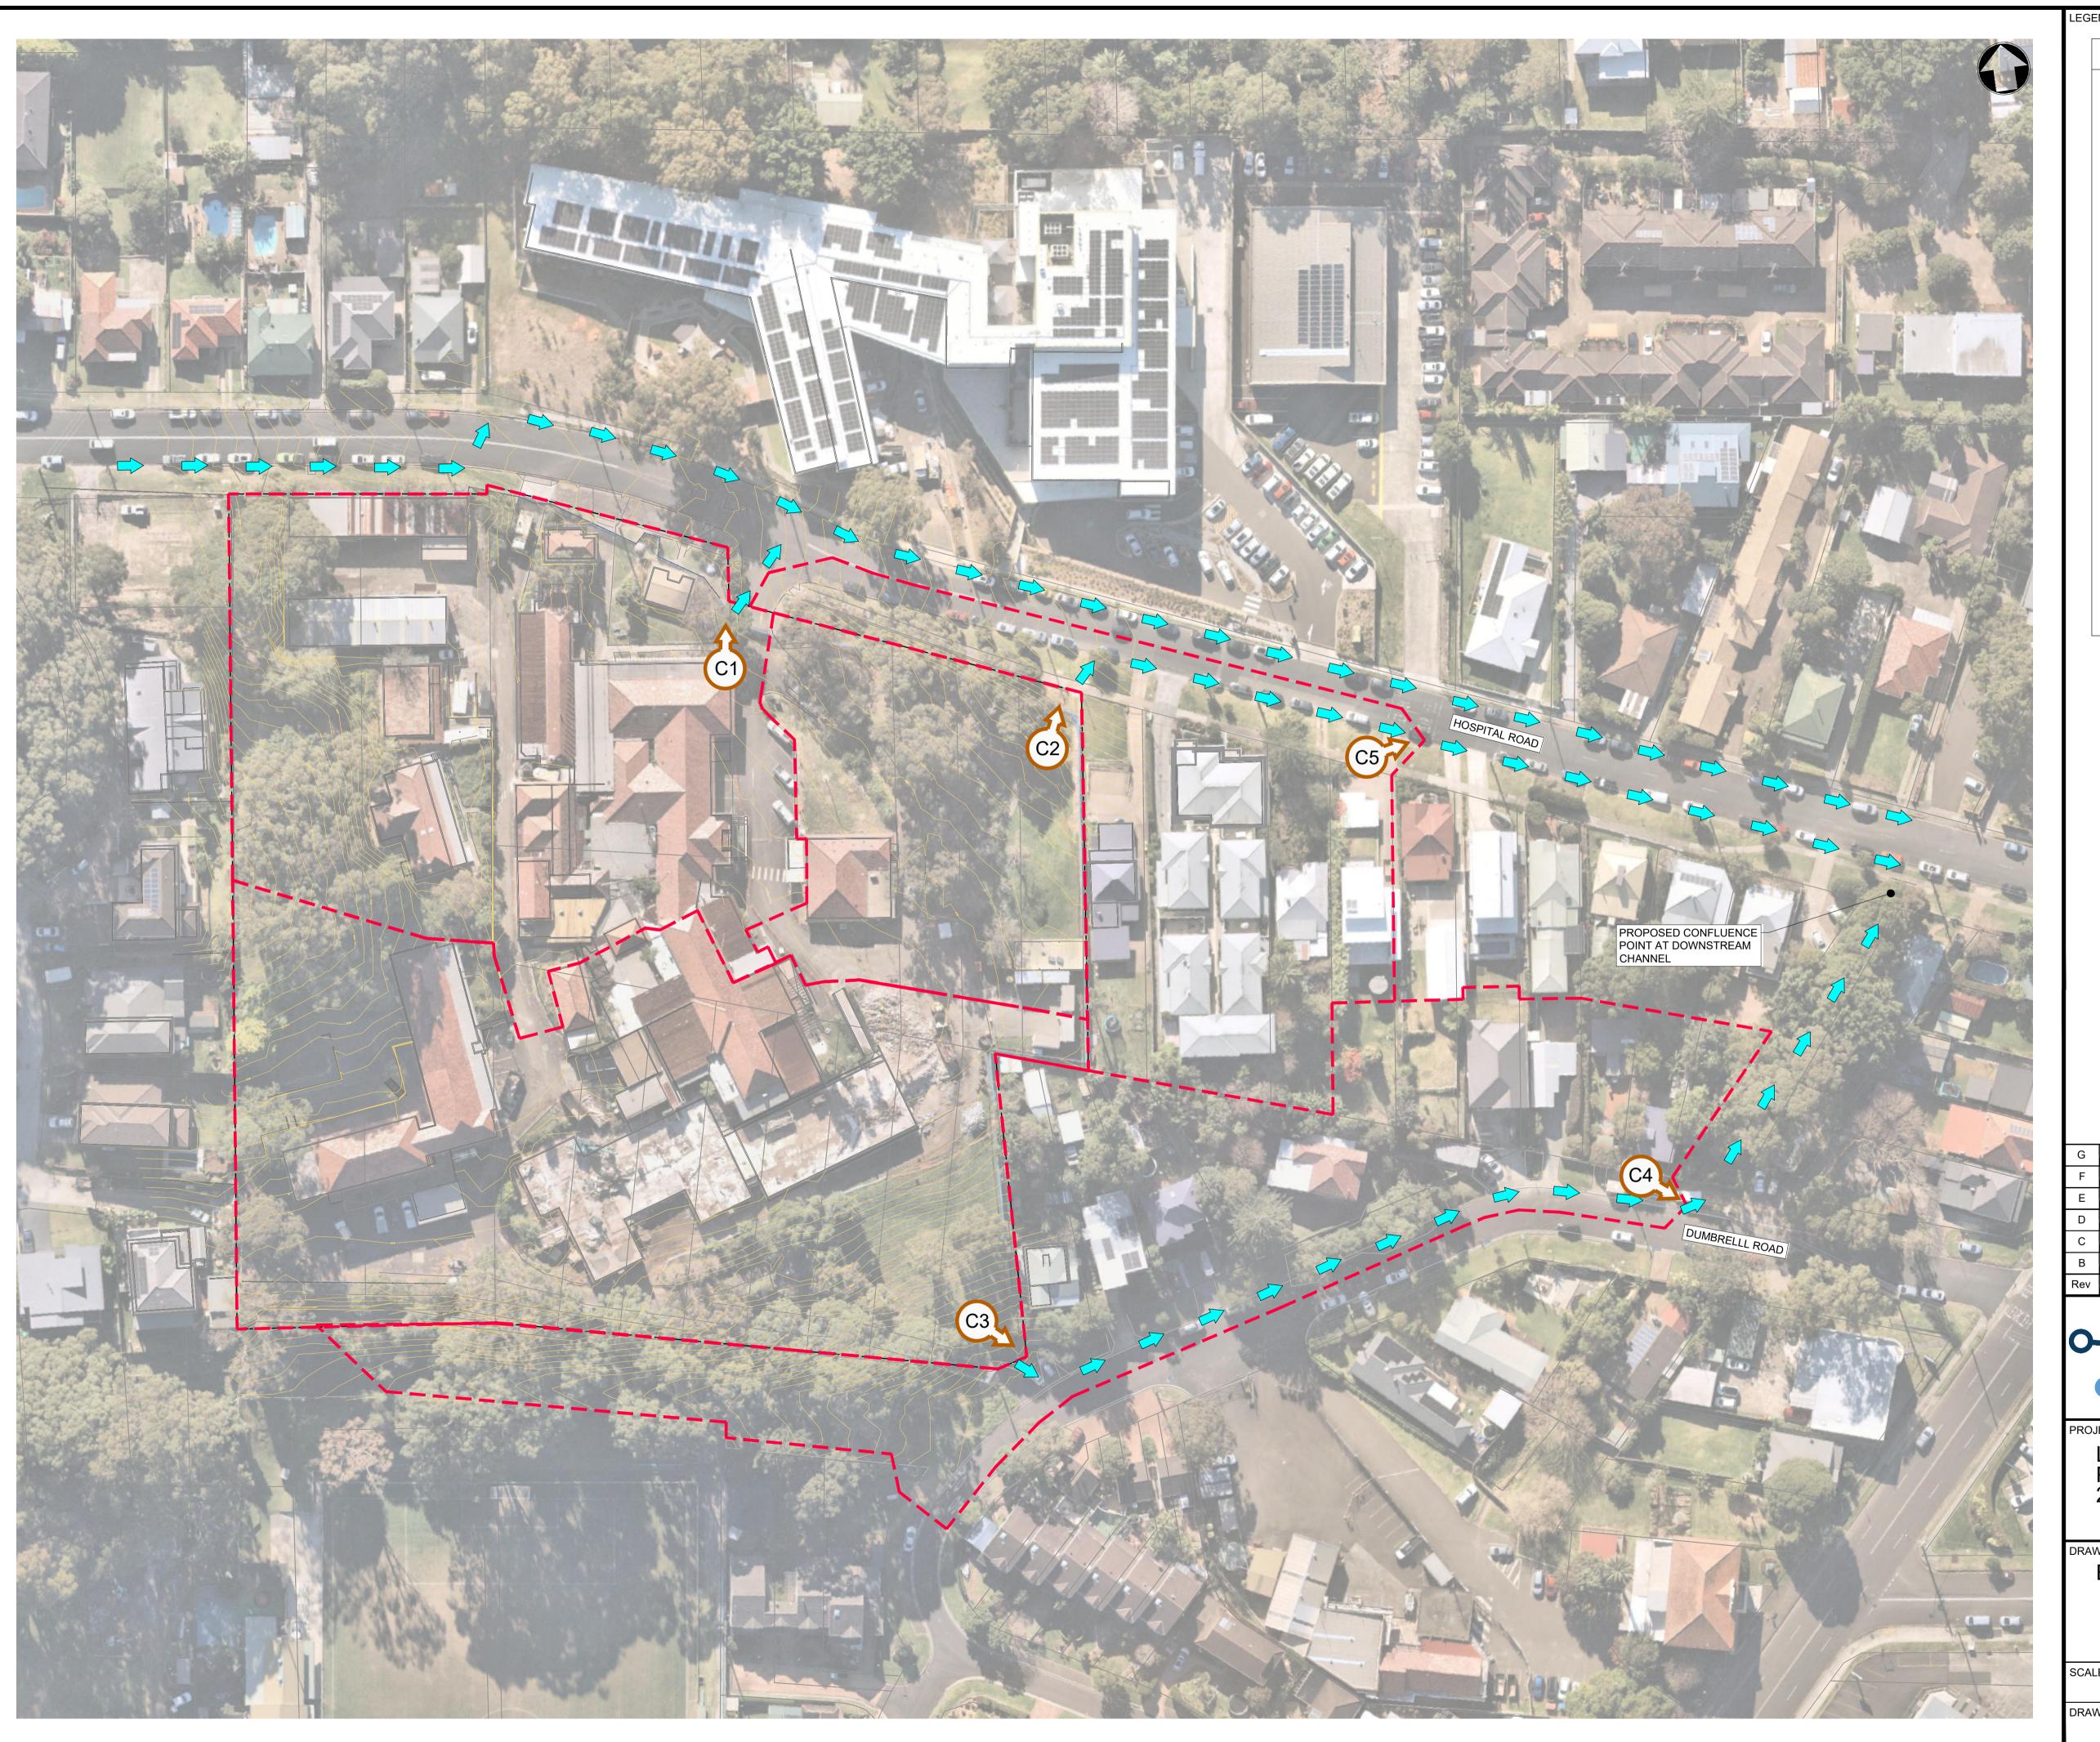

# LEGEND



EXISTING CATCHMENT BOUNDARY



NORTHERN CATCHMENTS DRAINING TO HOSPITAL ROAD



= 0.89Ha @ 61% IMPERVIOUS



= 0.39Ha @ 61% IMPERVIOUS



SOUTHERN CATCHMENT DRAINING TO DUMBRELL ROAD



= 1.14Ha @ 54% IMPERVIOUS



EXISTING CONTRIBUTING CATCHMENT DRAINING TO DUMBRELL ROAD



= 0.88Ha @ 60% IMPERVIOUS



EXISTING CONTRIBUTING CATCHMENT DRAINING TO HOSPITAL ROAD



= 0.56Ha @ 60% IMPERVIOUS



EXISTING FLOW DIRECTION

G	03.10.24	RE-ISSUED FOR DA	VT	DR
F	14.05.24	RE-ISSUED FOR DA	VT	DR
Е	10.05.24	RE-ISSUED FOR DA	GAP	DR
D	28.03.24	RE-ISSUED FOR DA	JK	DR
О	19.10.23	RE-ISSUED FOR DA	MRN	DR
В	06.09.23	ISSUED FOR DA	MRN	DR
Rev	Date	Description	Drawn	Annr



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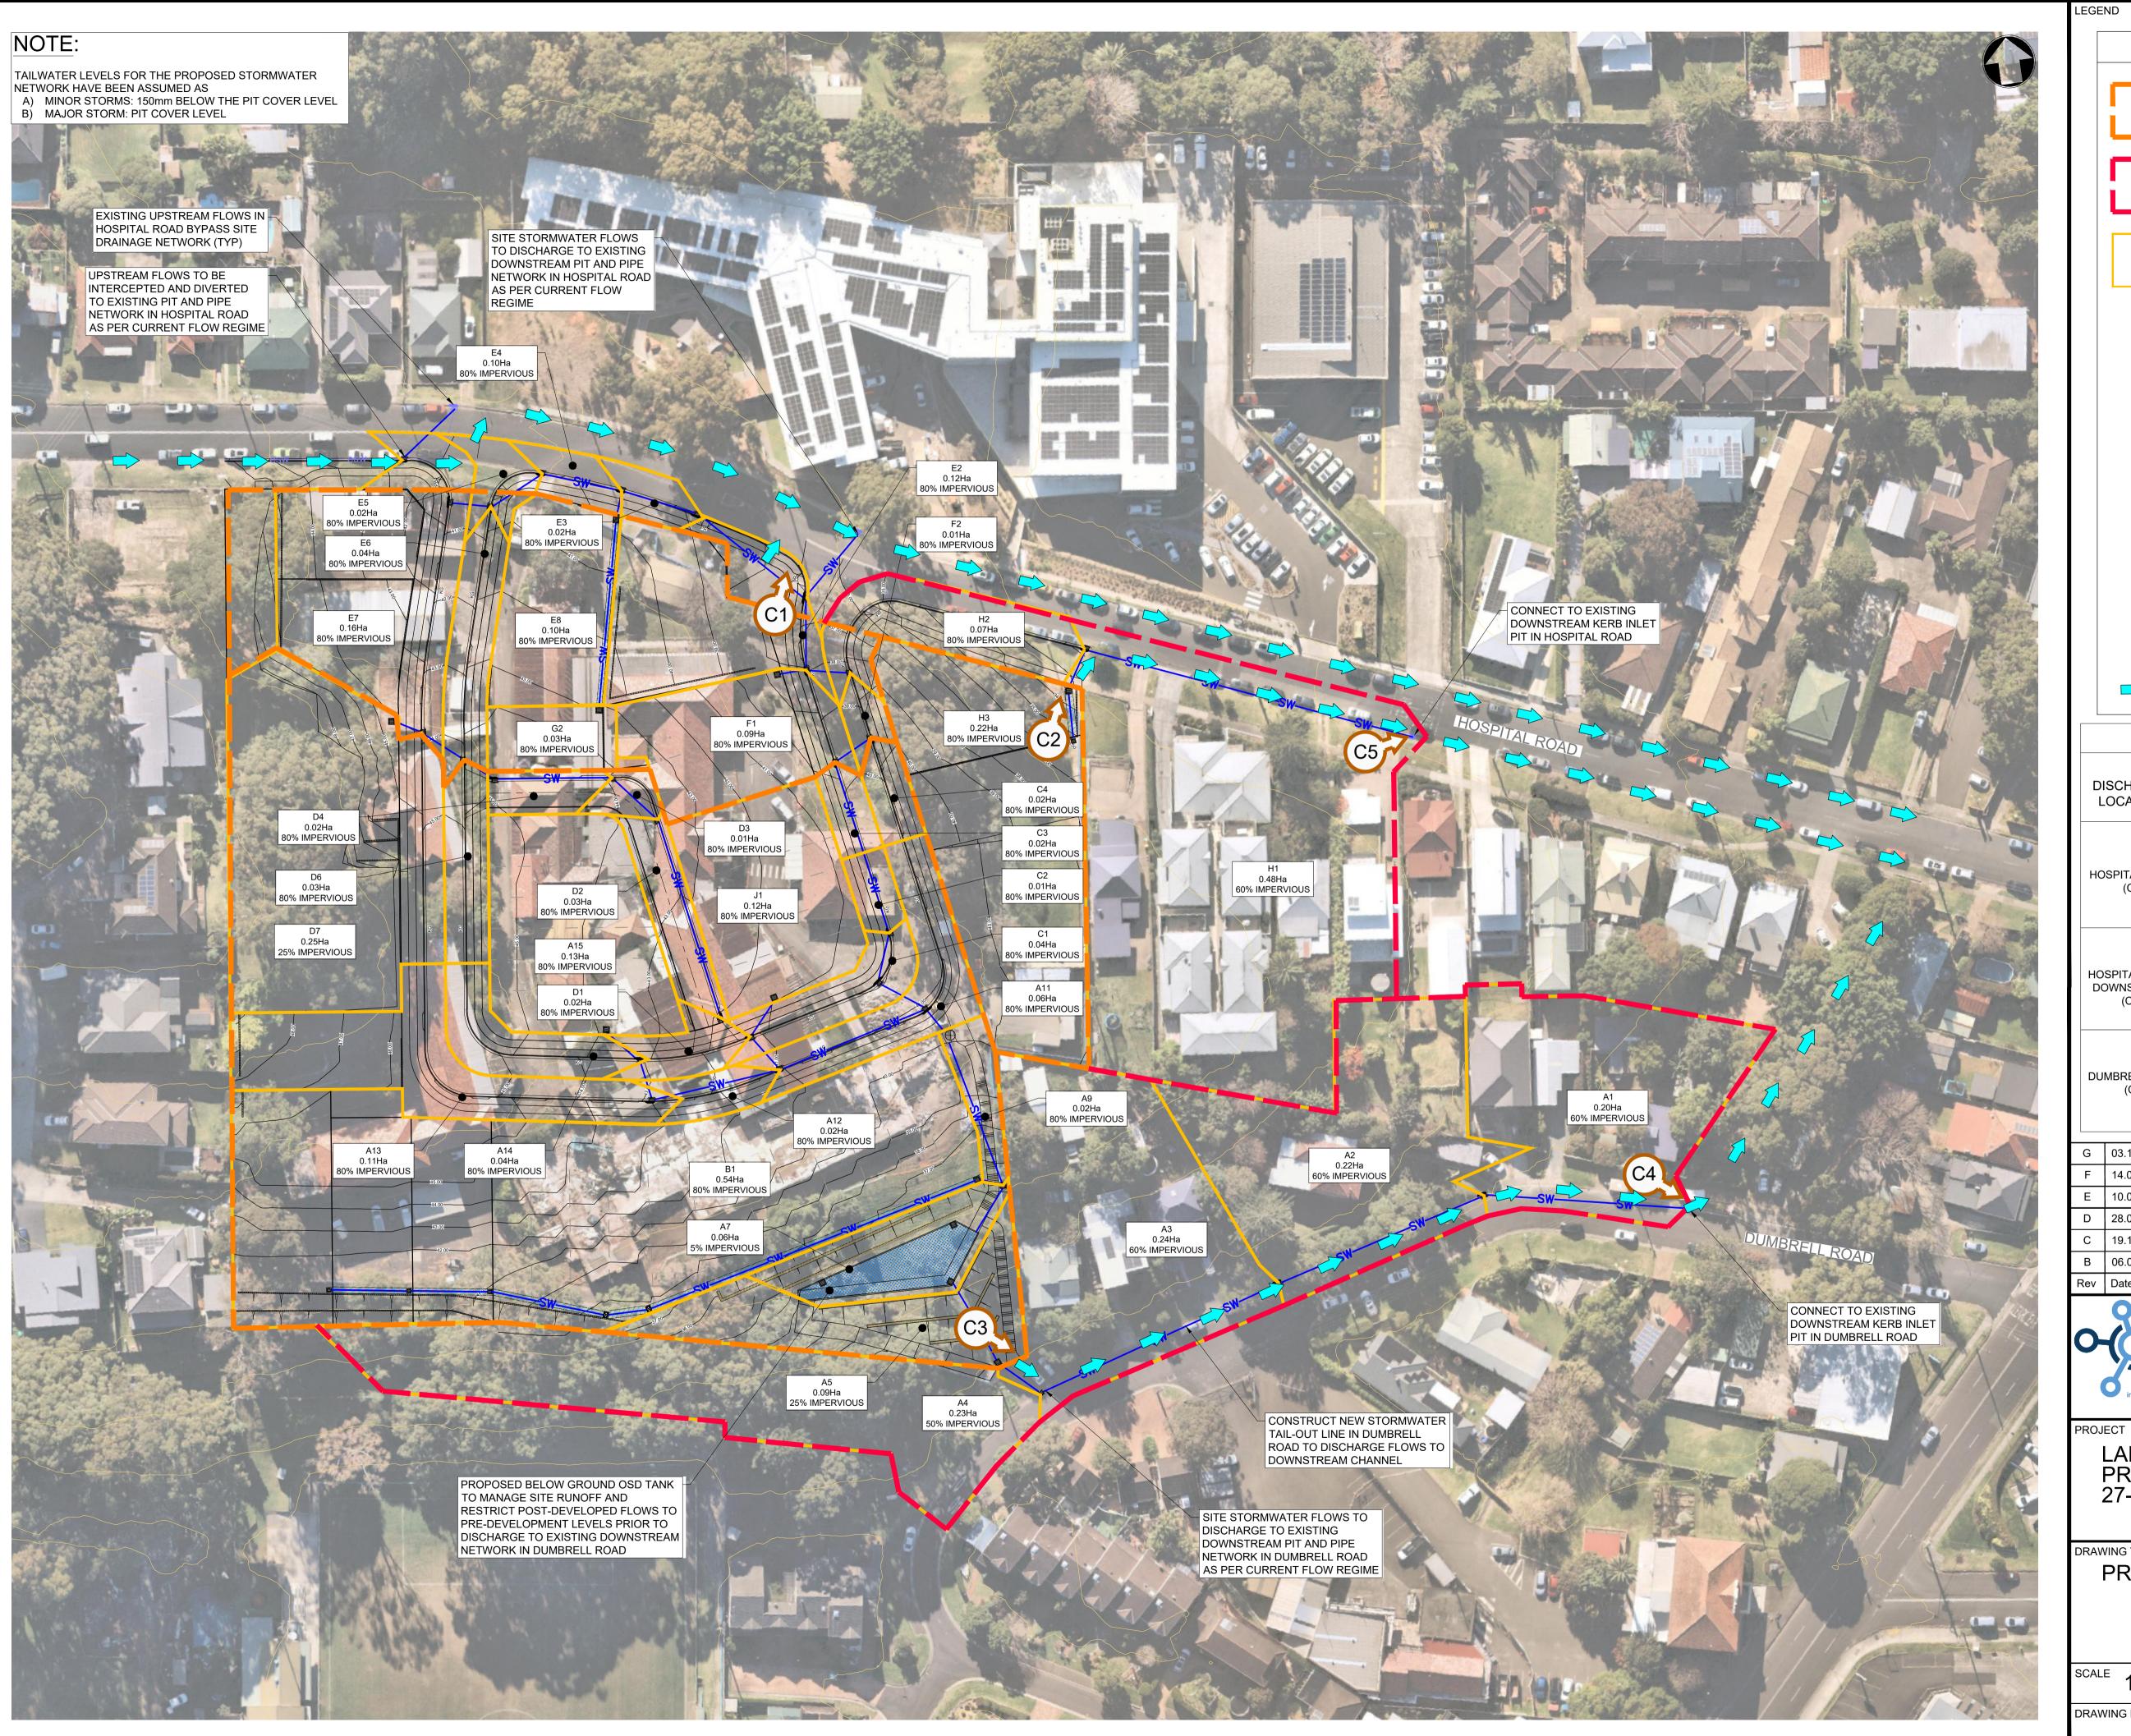
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EXISTING CATCHMENT PLAN

SCALE 1:600

STATUS DA

DRAWING NO. 22-526-DA-C219 REV G



**LEGEND** 



PROPOSED CATCHMENT BOUNDARY





CONTRIBUTING CATCHMENT BOUNDARY FROM EXISTING LOTS ALONG DUMBRELL ROAD / HOSPITAL ROAD



PROPOSED SUB-CATCHMENT BOUNDARY



PROPOSED SITE CATCHMENT DRAINING TO HOSPITAL ROAD =



PROPOSED SITE CATCHMENT DRAINING TO HOSPITAL ROAD = 0.22Ha



PROPOSED SITE CATCHMENT DRAINING TO DUMBRELL ROAD =



EXISTING CONTRIBUTING CATCHMENT DRAINING TO DUMBRELL ROAD =



EXISTING CONTRIBUTING CATCHMENT DRAINING TO HOSPITAL ROAD =



EXISTING FLOW DIRECTION

# PRE-POST COMPARISON

-	•		• •
DISCHARGE LOCATION	ARI	PRE-DEVELOPED PEAK DISCHARGE (m³/s)	POST-DEVELOPED PEAK DISCHARGE (m³/s)
	5yr	0.405	0.275
	10yr	0.474	0.322
HOSPITAL ROAD	20yr	0.558	0.385
(C1)	50yr	0.629	0.430
	100yr	0.715	0.490
	5yr	0.434	0.357
	10yr	0.508	0.425
HOSPITAL ROAD DOWNSTREAM	20yr	0.598	0.492
(C5)	50yr	0.674	0.555
	100yr	0.765	0.630
	5yr	0.895	0.835
	10yr	1.050	0.935
DUMBRELL ROAD (C4)	20yr	1.240	1.070
(04)	50yr	1.390	1.200
	100yr	1.580	1.330

G	03.10.24	RE-ISSUED FOR DA	VT	DR
F	14.05.24	RE-ISSUED FOR DA	VT	DR
Е	10.05.24	RE-ISSUED FOR DA	GAP	DR
D	28.03.24	RE-ISSUED FOR DA	JK	DR
С	19.10.23	RE-ISSUED FOR DA	MRN	DR
В	06.09.23	ISSUED FOR DA	MRN	DR
Rev	Date	Description	Drawn	Appr



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DRAWING TITLE

PROPOSED CATCHMENT PLAN

SCALE 1:600

STATUS

DRAWING NO. 22-526-DA-C220 REV G

